



DISCRIPTION LETTER

We are submitting an application to build a two story contemporary 2 bedrooms and 2.5 bathrooms house with 1095 sqft of living area. The APN for this lot is 062-215-080, zoning is R1U and the house will be equipped with fire sprinkler.

We are requesting for variances in connection with the construction of this brand-new 2-story house on a substandard lot located at Haight St., This request seeks relief from certain zoning regulations due to the unique size and configuration of the property, as allowed under Section 16.82.340(B) of the Zoning Ordinance.

The lot, which measures only 2,064 square feet, is significantly smaller than the minimum required lot size of 5,000 square feet typically required for residential properties in this zoning district. As per the zoning ordinance, for lots under 5,000 square feet, the Floor Area Limit (FAL) is determined through a Use Permit review by the Planning Commission. Given the constraints of our lot size, we are proposing a living area of 1,095 square feet, which we believe is way below the average for new homes in the city.

To ensure that the new home is both functional and in compliance with the spirit of the zoning regulations, we are requesting the following variances:

1. **Variance for Interior Side Yard Setback:**

The standard interior side yard setback requirement is 5 feet. Due to the lot's narrow width (21 feet, 8 inches), we are requesting a reduction in the interior side yard setback to 2.5 feet. This modification will allow for a more efficient use of the limited space and provide sufficient area for the home's design, while still maintaining the privacy and safety of adjacent properties. Given the size limitations of the lot, this variance is crucial to ensure that we can build a home that meets the basic functional needs of a typical family, without overcrowding the site.

2. **Variance for Street Side Yard Setback:**

The standard street side yard setback requirement for this zone is 12 feet. Due to the narrow width of the lot, we are requesting a reduction to 6.5 feet for the street side setback. This reduction is the maximum allowable while still preserving an adequate buffer for the front yard area and maintaining the overall character of the street. With the lot width being only 21 feet 8 inches, reducing the setback will help us achieve a buildable width of 13 feet, which is necessary for the overall livability and design of the home. Without this variance, we would be unable to construct a functional home that complies with the zoning ordinance but still meets modern living standards.

3. **Variance for Rear Yard Setback:**

The required rear setback is 20 feet, which typically ensures adequate space between

properties. However, due to the substandard lot size, we are requesting a reduction of the rear yard setback to 13 feet. This adjustment is necessary to provide a reasonable outdoor area while still conforming to the overall intent of the zoning regulations. The proposed setback ensures that the home will still allow for proper light, air, and access to the rear of the property without over-encroaching on neighboring properties. The reduced setback will not negatively impact the privacy or quality of life for nearby residents.

4. Variance for Daylight Plane Height:

The daylight plane regulations, which govern the maximum height allowed for a structure's exterior walls to ensure access to light and air, typically restrict the height to 19 feet, 6 inches. Given the design and limited size of the lot, we are requesting a variance to allow the daylight plane to extend to 23 feet, 11 inches. This increase will enable the construction of a two-story home with adequate ceiling heights for both floors. Without this variance, the design of the home would be severely constrained, potentially leading to an impractical or uncomfortable living space. The requested height variance is necessary to provide adequate living conditions while maintaining the spirit of the zoning ordinance by preserving light and air access for neighboring properties.

Each of these variances is essential to achieving a balanced and livable development given the constraints imposed by the lot's size and shape. The current lot configuration presents challenges that are beyond the control of the property owner and significantly limit the potential for development. Without these variances, it would be impossible to construct a reasonable and livable home that meets the needs of modern families. The proposed variances are designed to ensure the home fits within the broader context of the neighborhood while also providing a functional, sustainable space for the property owner.

We believe that these adjustments align with the zoning ordinance's purpose of promoting responsible and harmonious development in the community, and we appreciate your thoughtful consideration of our request.

Thank you!

Mohammad Kasirossafar



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DESIGNER SIGNATURE:

Masrosafar

PROJECT:
HAIGHT RESIDENCE
 0 HAIGHT ST.,
 MENLO PARK, CA 94025

REVISION TABLE:




SHEET TITLE:

PROPOSED FLOOR PLANS


PROJECT ID: 0654
 DATE: 07/24/2024
 SCALE: AS NOTED
 DRAWN BY: SIMAJAH

SHEET NO.:

A-3

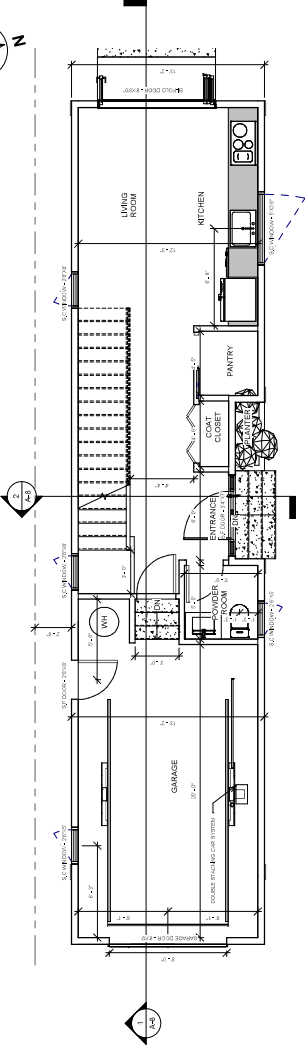

1 FIRST FLOOR PLAN
 1/4" = 1'-0"

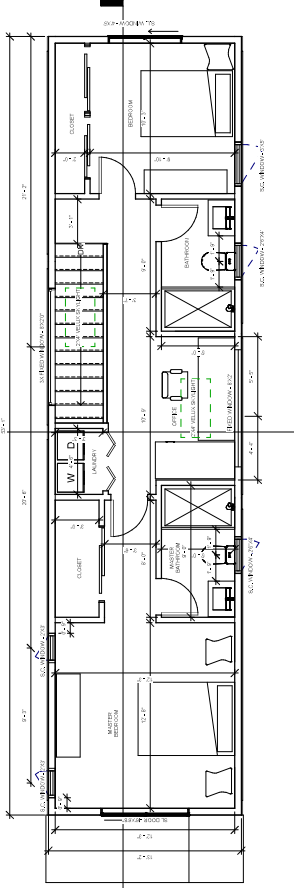


2 SECOND FLOOR PLAN
 1/4" = 1'-0"

KEY NOTES:

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NOTES:
 1) ALL PLUMBING FIXTURES AND FITTINGS SHALL MEET THE STANDARDS REFERENCED IN TABLE 1701.1 OF THE 2022 CALIFORNIA PLUMBING CODE, CBSFC SECTION 1701.1.1. THE INSPECTOR SHOWING THE FRAMING MEMBERS DO NOT EXCEED 3) THAT HEATING AND AIR-CONDITIONING SYSTEMS SHALL BE DESIGNED IN ACCORDANCE WITH THE REQUIREMENTS OF 4) DRYER EXHAUST DUCT MUST BE EQUIPPED WITH A BACK-DRAFT DAMPER WITH NO SCREEN, THE DUCT IS LIMITED TO 14 FEET IN LENGTH FROM THE POINT OF TERMINATION. REDUCE THIS LENGTH BY 2 FEET FOR EVERY ELBOW IN EXCESS OF TWO (ENCL 504.4)

LEGEND	
---	ROOF LINES
---	WALLS TO ADD
T	PROVIDE TEMPERED GLASS
E	EGRESS WINDOW TO COMPLY WITH DETAIL#2 SHEET A-15

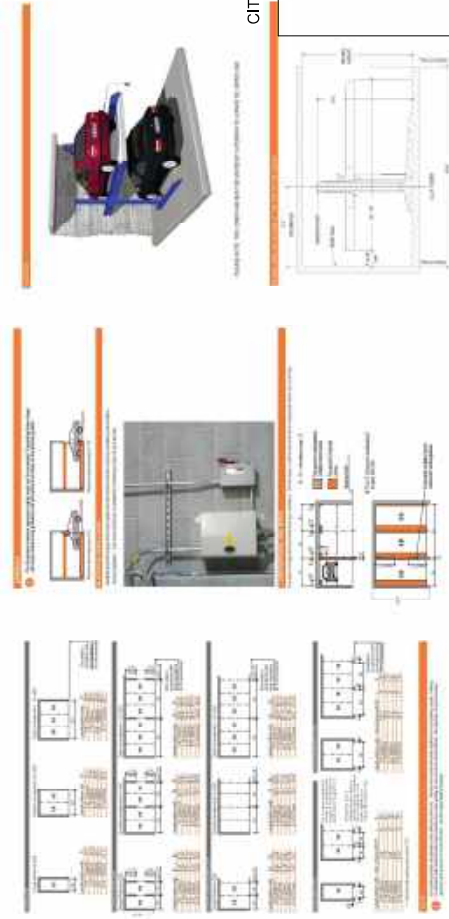

CITY STAMP PLACE



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PROJECT:

HAIGHT RESIDENCE

0 HAIGHT ST.,
 MENLO PARK, CA 94025

REVISION TABLE:



SHEET TITLE:

PROPOSED ELEVATIONS

PROJECT ID: 0534


DATE: 07/24/2024

SCALE: AS NOTED

DRAWN BY: SINAJAH

SHEET NO.:

A-4

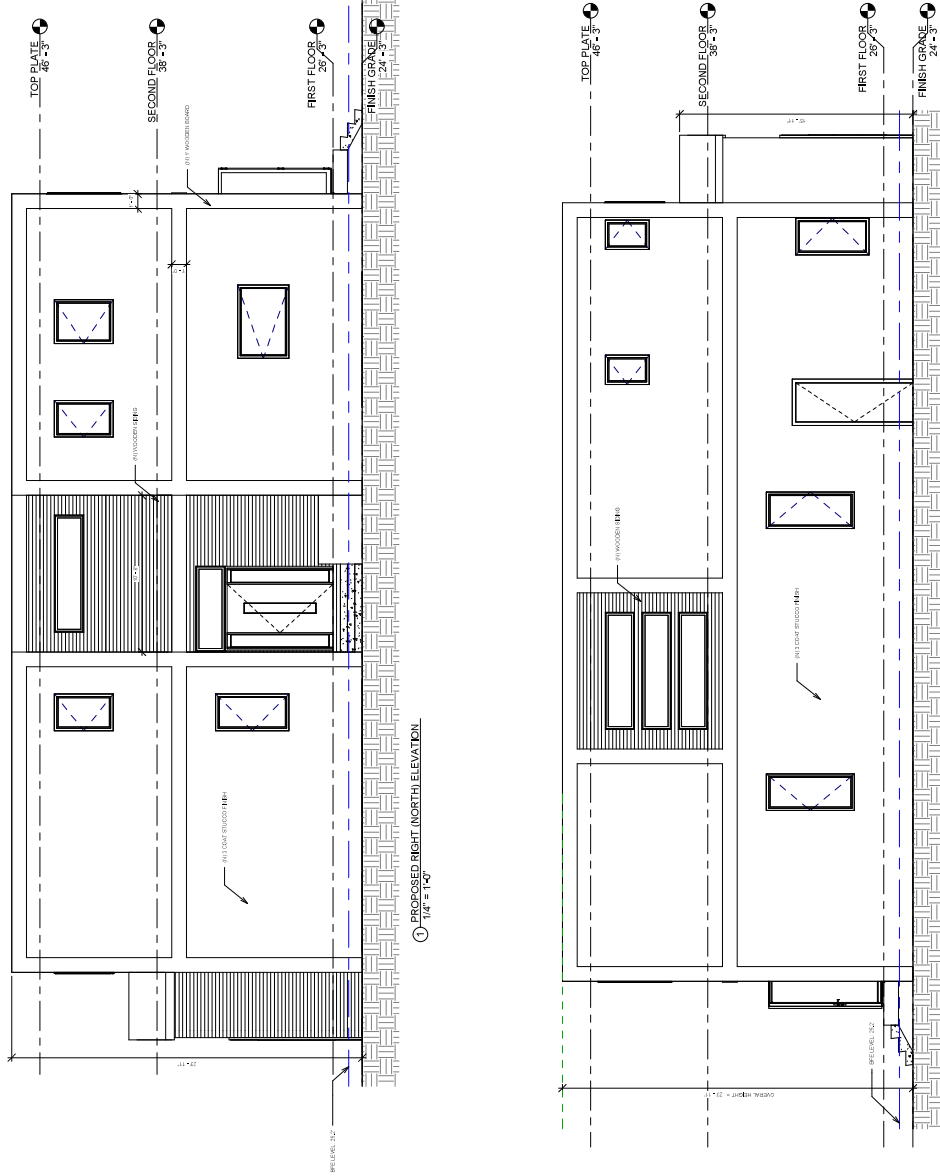

CITY STAMP PLACE



- KEY NOTES:
- 1) FINISH GRADE WITHIN 10' OF THE HOUSE SHALL HAVE A MIN. 5% SLOPE AWAY FROM FOUNDATION FOR PERVIOUS SURFACE AND MIN. 2% SLOPE FOR IMPERVIOUS SURFACE (CBC 1804.3).
 - 2) ON GRADED SITES, THE TOP OF ANY EXTERIOR FOUNDATION SHALL EXTEND ABOVE THE ELEVATION OF THE STREET GUTTER AT A POINT OF MINIMUM 12" ABOVE THE FINISH GRADE. ON SLOPES, THE MINIMUM SHALL BE 12" INCHES PLUS 5%.
 - 3) EXISTING DRAINAGE SHALL REMAIN THROUGH OUT CONSTRUCTION.
 - 4) ROOFING MATERIAL SHALL HAVE 2-LAYERS OF #30 FELT AS UNDERLAY AND FASTENED TO ROOF SHEATHING WITH CORROSION RESISTANT FASTENERS, TYPICAL (CBC 1805.2.4)
 - 5) FLASHING (CBC 1807 AND CBC 1805.2.6-1805.2.6.1) PROVIDE ROOF OPENINGS. FLASHING SHALL BE A MINIMUM 26 GAUGE CORROSION-RESISTANT GALVANIZED METAL.
 - 6) DRIP EDGE (CBC 1807.2.8.3 AND CBC 1805.2.6.5) PROVIDE A DRIP EDGE OF THE ROOF SHEATHING SHALL BE OVERLAPPED A MINIMUM OF 2 INCHES. THE DRIP EDGE SHALL EXTEND 1/4" INCH BELOW THE ROOF SHEATHING AND A MINIMUM OF 2 INCHES UP THE ROOF DECK. THE DRIP EDGE SHALL BE INSTALLED OVER THE DRIP EDGE ALONG THE EAVES, AND UNDER THE DRIP EDGE IF ALLOWED BY THE MANUFACTURER.
 - 7) WEATHER RESISTIVE BARRIERS SHALL BE INSTALLED AS REQUIRED IN SECTION R703.2 AND, WHERE APPLIED OVER WOOD-BASED SHEATHING, SHALL INCLUDE A WATER-RESISTIVE VAPOR-PERMEABLE BARRIER WITH A MINIMUM OF AT LEAST EQUIVALENT TO TWO LAYERS OF GRADE D PAPER (R703.6.3)
 - 8) FLASHINGS WITH POSTS AND GASKETS IN ASTER SHALL NOT BE LESS THAN THREE COATS WHEN APPLIED OVER METAL FLASH OR WEATHER AND SHALL BE NOT LESS THAN TWO COATS WHEN APPLIED OVER MASONRY, CONCRETE, PRESSURE-PRESERVATIVE TREATED WOOD OR DECKING. CONCRETE, PRESSURE-PRESERVATIVE TREATED WOOD OR DECKING (R703.6.2)
 - 9) A MINIMUM 26 GA. GALVANIZED CORROSION-RESISTANT WEEP SCREED WITH (R703.6.1)
 - 10) MINIMUM VERTICAL ATTACHMENT FLANGE OF 3-1/2 INCHES PROVIDED AT A MINIMUM SQUARE FOOT FOR EACH 150 SQUARE FEET OF UNDER-FLOOR OR 2 INCHES ABOVE PAVED AREA.
 - 11) WINDOWS AND GLAZED DOORS MUST HAVE LABELS FOR "U-FACTOR" & "SHGC" AS REQUIRED PER ENERGY CODE. SEE ENERGY COMPLIANCE INFORMATION ON SHEET 1-24.
 - 12) CRAWL SPACE VENTS SHALL NOT OCCUR AT SHEAR WALLS.
 - 13) PROVIDE ADDITIONAL CRAWL SPACE VENTS PER (E) VENTS BLOCKED BY NEW ADDITION.
 - 14) MINIMUM NET AREA OF VENTILATION OPENINGS SHALL NOT BE LESS THAN 1 SQUARE FOOT FOR EACH 150 SQUARE FEET OF UNDER-FLOOR AREA (R403.2).
 - 15) ONE VENTILATION OPENING SHALL BE WITHIN 3 FEET OF EACH CORNER OF THE BUILDING (R403.2).
 - 16) 50% TO 70% OF EYEBROW VENTS SHALL BE IN THE UPPER 1/3 OF ROOF STRUCTURE.
 - 17) PROVIDE ADDITIONAL ATTIC VENTS PER (E) VENTS BLOCKED BY NEW ROOF.



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DESIGNER SIGNATURE:

Masrosafar

PROJECT:
HAIGHT RESIDENCE
 0 HAIGHT ST.,
 MENLO PARK, CA 94025

REVISION TABLE:



SHEET TITLE:


PROPOSED ELEVATIONS

PROJECT ID:	0534
DATE:	07/24/2024
SCALE:	AS NOTED
DRAWN BY:	SINAJAH


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A-5



CITY STAMP PLACE

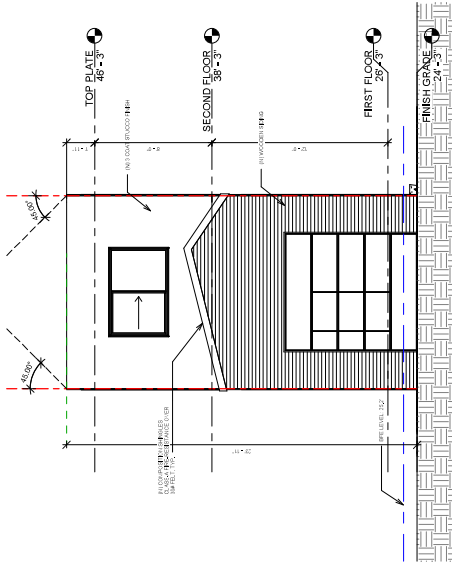

② PROPOSED FRONT (EAST) ELEVATION
 1/4" = 1'-0"

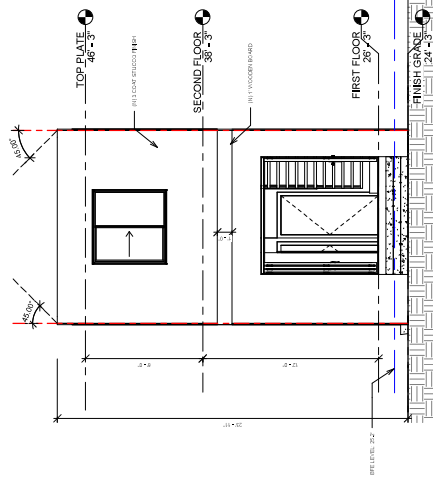

① PROPOSED REAR (WEST) ELEVATION
 1/4" = 1'-0"

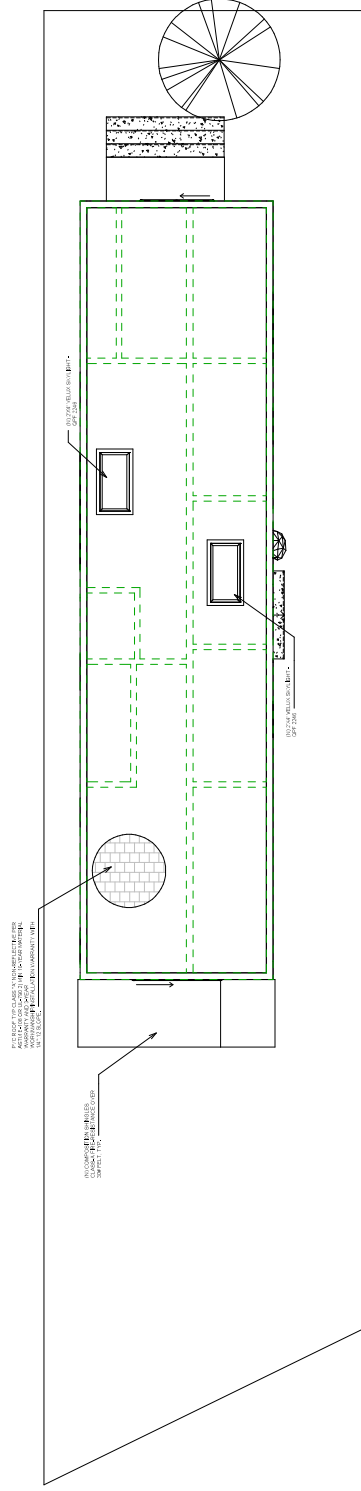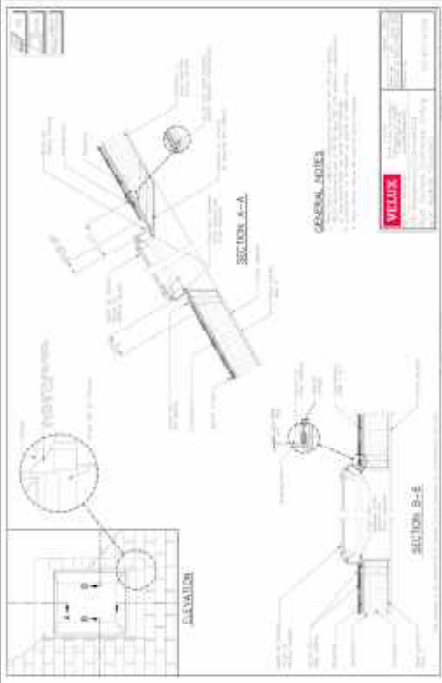

NOTES
1) FINISHED ROOFING MATERIAL SHALL BE INSTALLED AND COMPLETED PRIOR TO FRAME INSPECTION.
LEGEND
ROOF LINES
PROPOSED WALLS

CITY STAMP PLACE

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 0 HAIGHT ST.,
 MENLO PARK, CA 94025

REVISION TABLE:

SHEET TITLE:
PROPOSED ROOF PLAN

PROJECT ID:	0534
DATE:	07/24/2024
SCALE:	AS NOTED
DRAWN BY:	SIMAJAH

SHEET NO.:
A-6



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SHEET TITLE:


FLOOR AREA LIMIT
 CALCULATIONS

PROJECT ID:	0534
DATE:	07/24/2024
SCALE:	AS NOTED
DRAWN BY:	SIMAJAH


SHEET NO.:

A-7

CITY STAMP PLACE

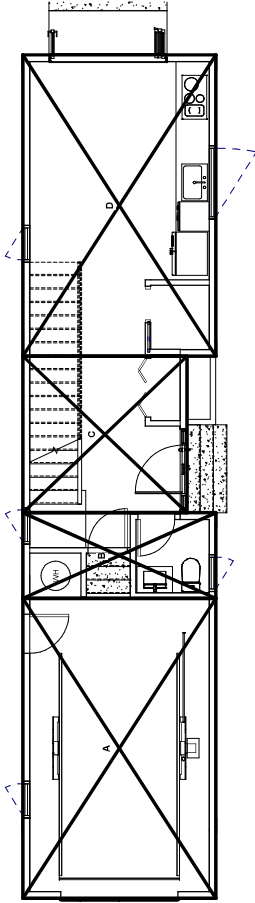

① FIRST FLOOR PLAN AREA
 1/4" = 1'-0"

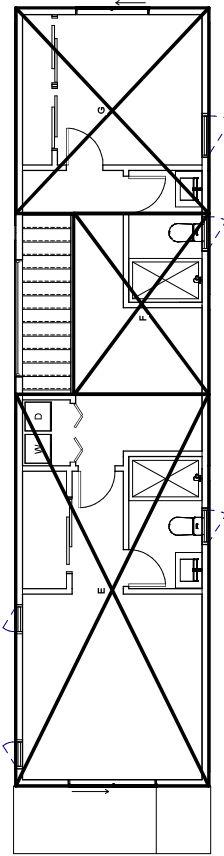

② SECOND FLOOR PLAN AREA
 1/4" = 1'-0"

FLOOR AREA LIMIT CALCULATION			
AREA	DIMENSIONS	SF	
A	20'6" X 13'2"	270	
B	5'10" X 13'2"	77	
C	10'8" X 11'2"	119	
D	20'7" X 13'2"	271	
E	26'9" X 13'2"	351	
F	12'5" X 9'3"	114	
G	14'0" X 13'2"	184	
TOTAL FAL:			1386



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Masrosafar

PROJECT:
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 0 HAIGHT ST.,
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REVISION TABLE:




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PROPOSED SECTION


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 DATE: 07/24/2024
 SCALE: AS NOTED
 DRAWN BY: SMH

SHEET NO.:

A-8

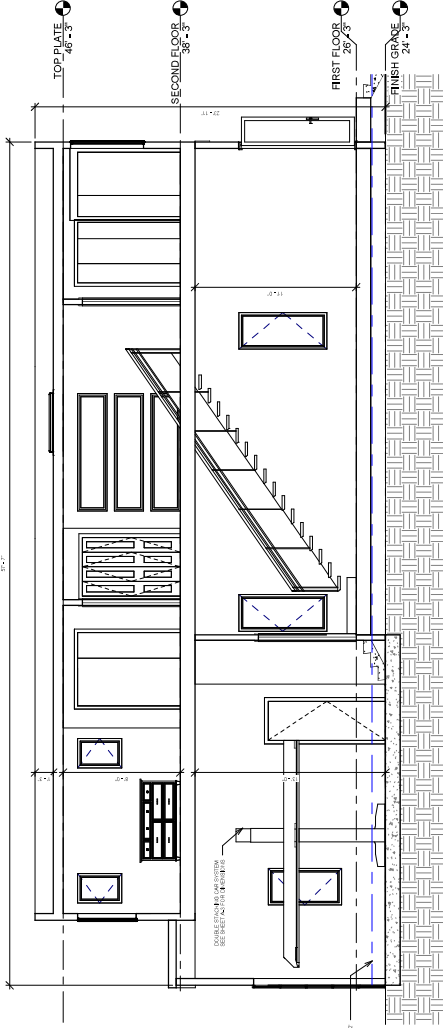


Section 1
 1/4" = 1'-0"

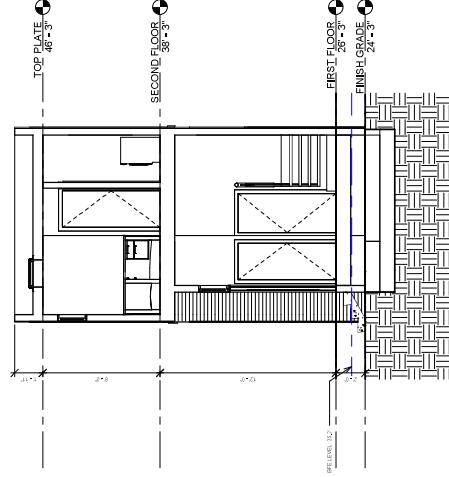

Section 2
 1/4" = 1'-0"

CITY STAMP PLACE

BASE FLOOD ELEVATION: 25.2'
 MINIMUM FINISH FLOOR ELEV: 24'-3"

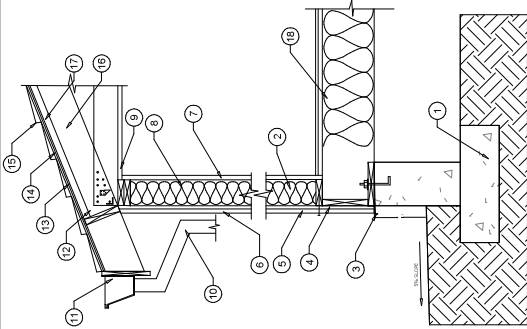

Section 3
 1/4" = 1'-0"

KEY NOTES:

- 1 FOUNDATION PER PLAN
- 2 STUD WALL PER PLAN
- 3 STUCCO WEEP SCREED @ FOUNDATION PLATE LINE, 4" MIN. ABOVE PAVED AREAS, TYP.
- 4 WALL SHEATHING PER PLAN
- 5 2 LAYERS OF GRADE D PAPER AS WATER-RESISTIVE BARRIER
- 6 3 COAT OF 7/8" STUCCO APPLIED OVER METAL LATH OR WOOD SIBINGS
- 7 1/2" SHEETROCK
- 8 WALL INSULATION PER TITLE 24
- 9 5/8" SHEETROCK
- 10 NONCOMBUSTIBLE OR A MIN. OF SCHEDULE 40 PLASTIC PIPE DOWNSPOUT, TYP.
- 11 CORROSION RESISTANT GUTTER
- 12 ROOF FRAMING PER PLAN
- 13 ROOF SHEATHING PER PLAN
- 14 #30 FELT UNDERLAYMENT
- 15 ROOFING PER PLAN
- 16 ROOF INSULATION PER TITLE 24
- 17 1" AIR GAP BETWEEN INSULATION AND PLYWOOD.
- 18 FLOOR INSULATION PER TITLE 24

NOTES:
 1. SECTION 1 IS PROVIDED FOR SPATIAL REFERENCE ONLY. FOR ROOFING, FLOOR FRAMING, FLOOR SHEATHING, AND FOUNDATION PLAN DETAILS, SEE STRUCTURAL SHEETS, TYPICAL.
 2. FOR INSULATION R-VALUES, SEE T24 ENERGY CALCULATIONS.
 3. WOOD FRAMING MEMBERS, INCLUDING WOOD SHEATHING, THAT ARE IN CONTACT WITH EXTERIOR FINISHES SHALL BE PROTECTED FROM EXPOSED EARTH SHALL BE NATURALLY DURABLE OR PRESERVATIVE-TREATED WOOD, PER CRC R317.1(2).
 4. 3 COAT STUCCO FINISH TO MATCH EXISTING
 THE INDIVIDUAL LAYERS SHALL BE INSTALLED INDEPENDENTLY SUCH THAT EACH LAYER IS FULLY ADHERED TO THE UNDERLYING LAYER. THE PLANE AND ANY FLASHING SHALL BE INSTALLED IN ACCORDANCE WITH SECTION R703.4) INTENDED TO DRAIN TO THE WATER-RESISTIVE BARRIER IS DIRECTED BETWEEN THE LAYERS.



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HAIGHT RESIDENCE

0 HAIGHT ST.,
 MENLO PARK, CA 94025

REVISION TABLE:



SHEET TITLE:

AREA PLAN &
 STREETSCAPE

PROJECT ID: 0634


DATE: 07/24/2024

SCALE: AS NOTED


DRAWN BY: SIMAJAH

SHEET NO.:


A-9

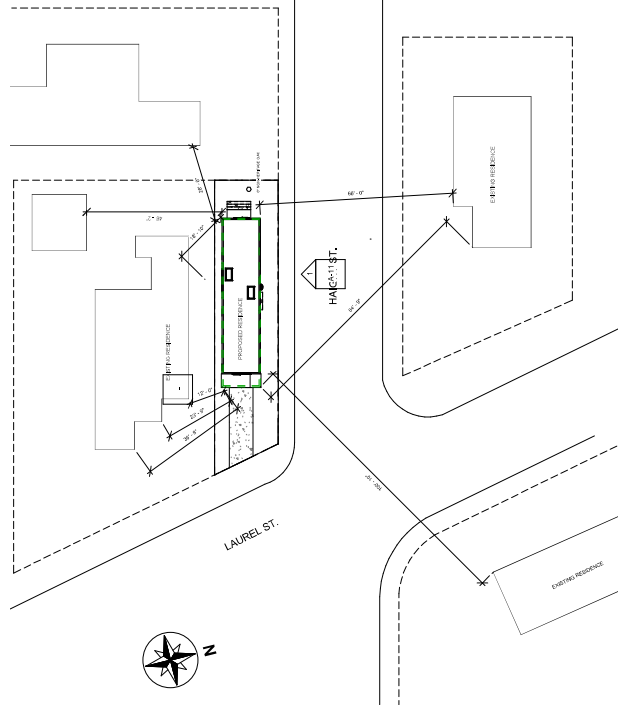

① AREA PLAN
 1" = 20'-0"

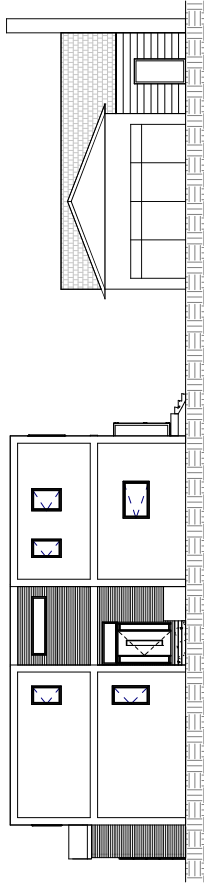



② PROPOSED STREETSCAPE (NORTH)
 1/8" = 1'-0"

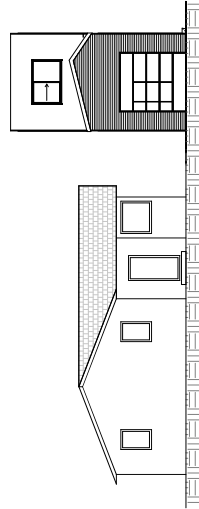

③ PROPOSED STREETSCAPE (EAST)
 1/8" = 1'-0"

CITY STAMP PLACE

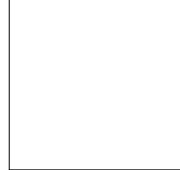

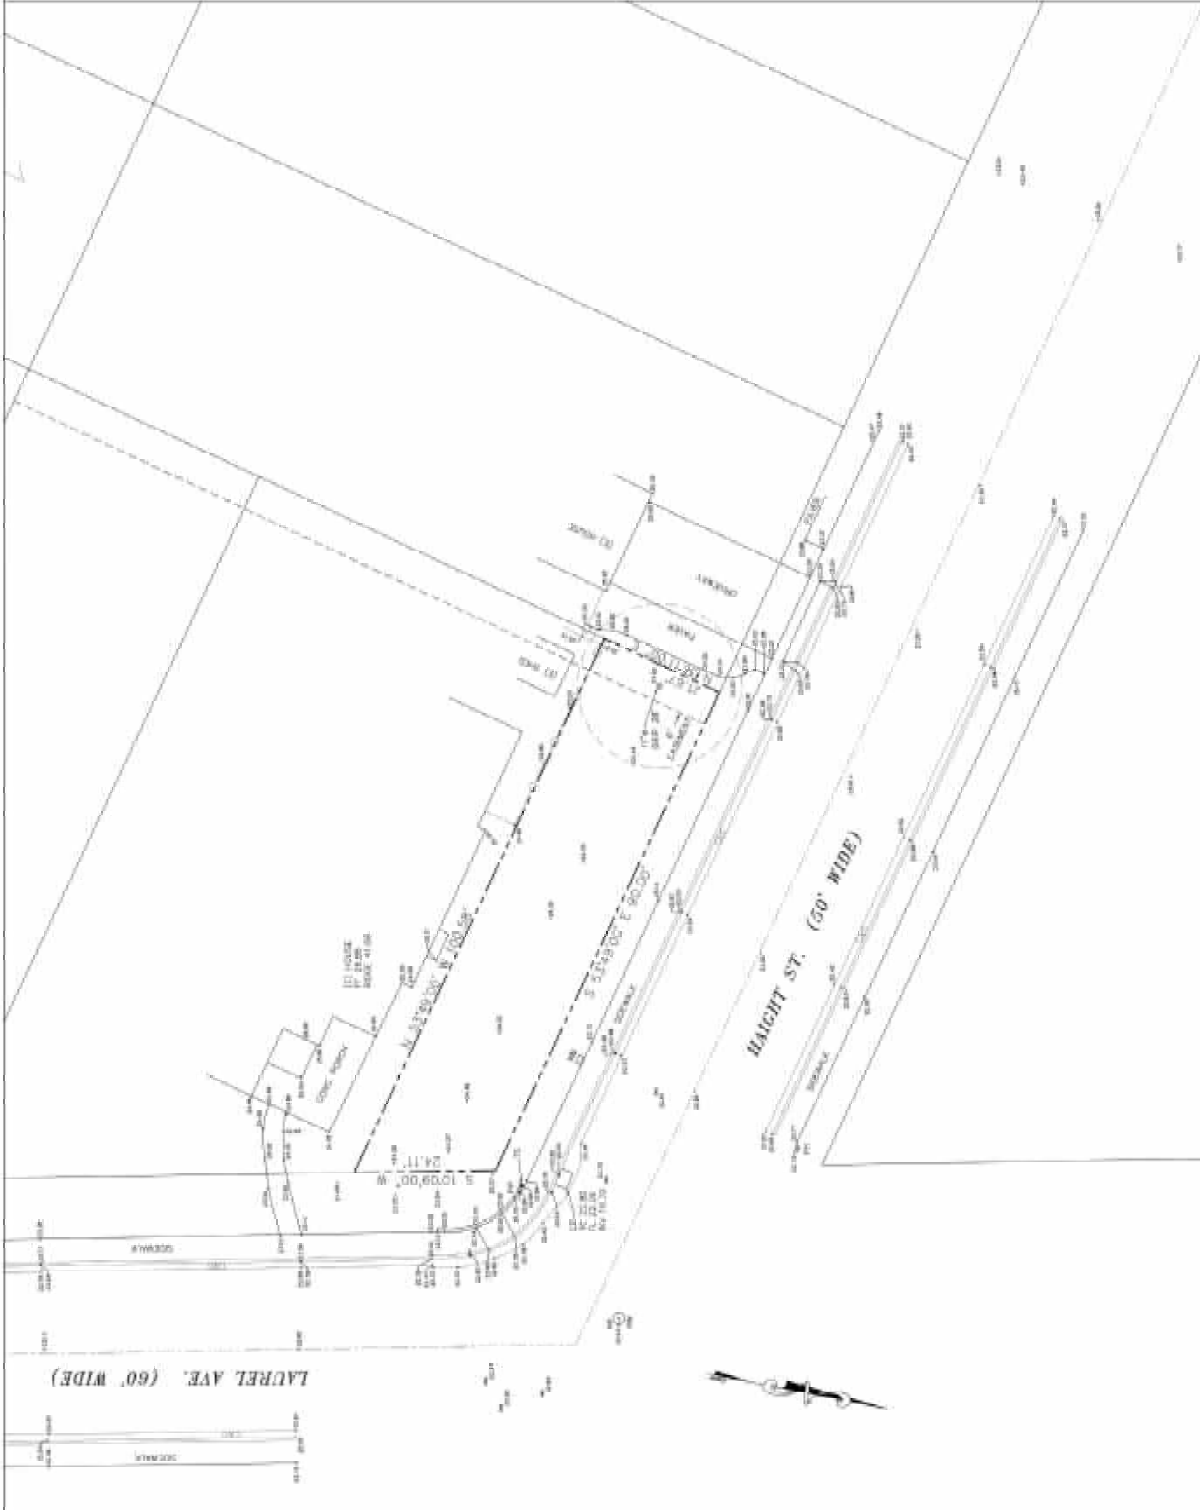

LEGEND

- STREET CENTERLINE
- PROPERTY LINE
- WOOD FENCE
- WATER METER
- GAS METER
- ELECTRIC METER
- PLUMBER
- POWER POLE
- PUBLIC UTILITY EASEMENT
- SANITARY SEWER MANHOLE
- STORM DRAINAGE MANHOLE
- FIRE HYDRANT
- CURB & GUTTER
- WATER VALVE

RECORDS INDEXING

A CITY THAT HAS MADE'S PLANNING WAS ESTABLISHED BY AN ACT OF THE STATE OF CALIFORNIA, CHAPTER 1099, STATUTES OF 1907, WHICH ACT WAS AMENDED BY CHAPTER 1099, STATUTES OF 1913, AND CHAPTER 1099, STATUTES OF 1917. THE ACTS WERE AMENDED BY CHAPTER 1099, STATUTES OF 1921, AND CHAPTER 1099, STATUTES OF 1925. THE ACTS WERE AMENDED BY CHAPTER 1099, STATUTES OF 1929, AND CHAPTER 1099, STATUTES OF 1933. THE ACTS WERE AMENDED BY CHAPTER 1099, STATUTES OF 1937, AND CHAPTER 1099, STATUTES OF 1941. THE ACTS WERE AMENDED BY CHAPTER 1099, STATUTES OF 1945, AND CHAPTER 1099, STATUTES OF 1949. THE ACTS WERE AMENDED BY CHAPTER 1099, STATUTES OF 1953, AND CHAPTER 1099, STATUTES OF 1957. THE ACTS WERE AMENDED BY CHAPTER 1099, STATUTES OF 1961, AND CHAPTER 1099, STATUTES OF 1965. THE ACTS WERE AMENDED BY CHAPTER 1099, STATUTES OF 1969, AND CHAPTER 1099, STATUTES OF 1973. THE ACTS WERE AMENDED BY CHAPTER 1099, STATUTES OF 1977, AND CHAPTER 1099, STATUTES OF 1981. THE ACTS WERE AMENDED BY CHAPTER 1099, STATUTES OF 1985, AND CHAPTER 1099, STATUTES OF 1989. THE ACTS WERE AMENDED BY CHAPTER 1099, STATUTES OF 1993, AND CHAPTER 1099, STATUTES OF 1997. THE ACTS WERE AMENDED BY CHAPTER 1099, STATUTES OF 2001, AND CHAPTER 1099, STATUTES OF 2005. THE ACTS WERE AMENDED BY CHAPTER 1099, STATUTES OF 2009, AND CHAPTER 1099, STATUTES OF 2013. THE ACTS WERE AMENDED BY CHAPTER 1099, STATUTES OF 2017, AND CHAPTER 1099, STATUTES OF 2021.



SHRUBS INDEXING

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PROJECT BENCHMARK:

STATION 10+00 (10+00.00)

NOTES:

1. ALL DIMENSIONS ARE GIVEN IN FEET AND DECIMAL FRACTIONS.
2. THE TOTAL AREA OF THIS PROJECT IS 10,000 SQ. FT.
3. THE CITY OF MENLO PARK IS NOT RESPONSIBLE FOR THE ACCURACY OF ANY INFORMATION CONTAINED HEREIN.
4. ALL DIMENSIONS SHOWN ARE APPROXIMATE.
5. THE FIELD NOTES OF THIS SURVEY SHALL BE KEPT AT THE OFFICE OF THE SURVEYOR.
6. THIS SURVEY IS A PRELIMINARY SURVEY. THE CITY OF MENLO PARK IS NOT A PROFESSIONAL ENGINEER OR ARCHITECT.

GRAPHIC SCALE



APN: 062-215-060 LUREI
 MENLO PARK, CA 94025
 APN: 062-215-080



SMP ENGINEERS
 CIVIL ENGINEERS—LAND SURVEYORS
 1524 Oak Lane
 Los Altos, CA 94024
 Tel: (650) 941-8255 Fax: (650) 941-8758

PRELIMINARY BOUNDARY AND TOPOGRAPHIC SURVEY MAP

T-1

CITY OF MENLO PARK

NO.	DESCRIPTION	DATE	BY
1	ISSUED FOR PERMIT	12/31/2023	JL