



Date: April 06, 2022
Project Address: 90 La Loma Dr., Menlo Park, CA 94025
Re: Project Description

The proposal contained within is to address the non-conforming Min. Lot width condition present at the site of 90 La Loma Dr. The minimum required lot width by zoning is 80', where the site observes a minimum lot width of 73'-8". Below is a full description of the proposed project.


The scope of the attached project involves the removal and demolition of the existing single family residence and garage, and the construction of a new 2 story, 4,000 sf Main Residence with a new 782 SF attached Accessory Dwelling Unit. The construction will also include a covered back patio with BBQ for the main residence and a small open back patio for the ADU, and any landscaping and site work related to those constructions including but not limited to, driveway, walkway, fences, and utility work.

The (N) Main Residence is a 2 story structure and contains a garage, kitchen, mudroom, laundry, pantry, powder room, living room, and family room on the main level, and 4 bedrooms and bathrooms, including the Master suite, on the second level. The attached ADU will contain 2 bedroom and 1 bathroom with a small kitchen and living area. Both structures are located at the front of the property in order to take full advantage of the natural daylight and optimize the backyard SF. Both the Main Residence and the ADU will be built with wood framing and be clad with stucco and have accent walls with wood siding. The material choices are both aesthetic and functional, emphasizing the simplicity of each structure and their contemporary architectural design. Windows and doors will be wood with metal cladding, allowing for decreased maintenance due to their durability. Both structures are simple forms with little to no protrusions, bay windows, dormers, etc. The proposed flat roof lines share the same composition and allow for the main residence to take advantage of consistent, high ceiling heights without obstructing the daylight plane.

Our clients have had informal discussions with their adjacent neighbors regarding their proposed constructions and are in the process of sending complete drawing set with an accompanying description letter. The neighbors have not expressed any concerns to our clients, but we are trying to be respectful of their privacy by using high, limited number of windows and/or through screen plantings along the fence line. Our clients are continuing conversations with their neighbors and any concerns will be addressed.

Sincerely,

Teodora Velkova, Design Associate
Ana Williamson Architect

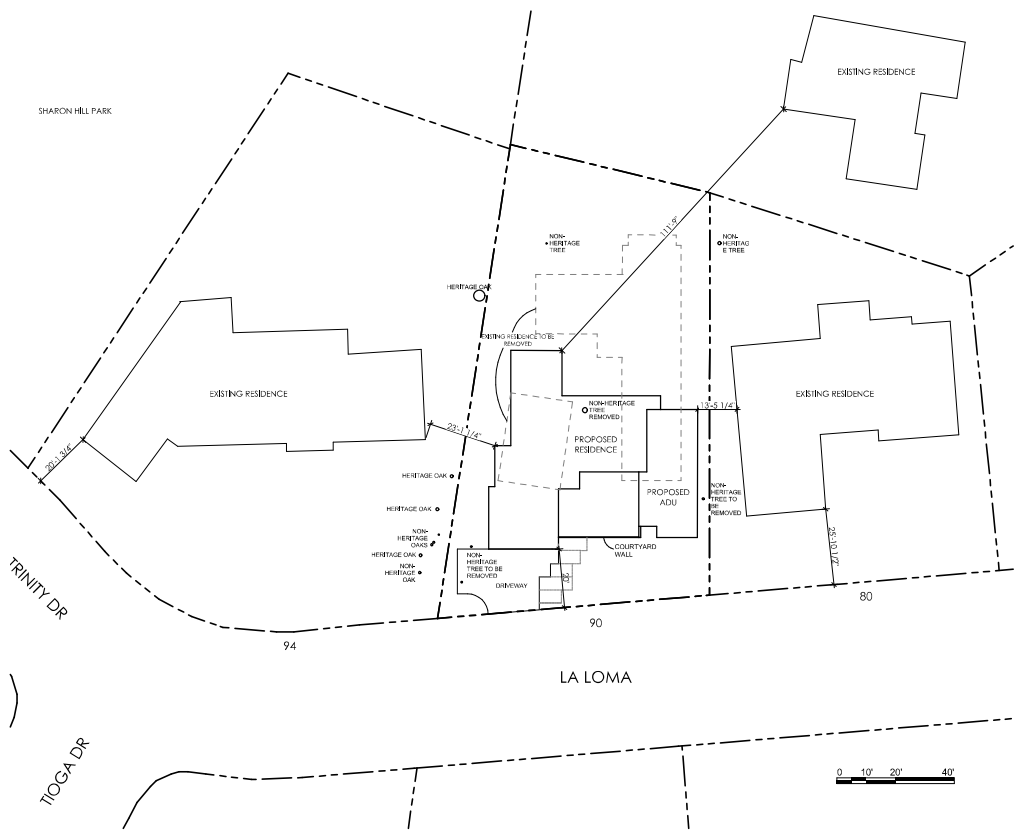

A AREA PLAN: 90 LA LOMA DR.
1/8" = 1'-0"



A STREETScape
3/16" = 1'-0"

FLOOR AREA CALCULATIONS

ALLOWABLE FLOOR AREA

MAX FLOOR AREA = 25% PARCEL AREA - 7,000 = 2,800
 = 0.25(11,200) - 7,000 = 2,800
 = **4,044 SF**

ADU FLOOR AREA ALLOWANCE = **800 SF**

TOTAL FLOOR AREA = **4,844 SF**

ALLOWABLE LOT COVERAGE

MAX LOT COVERAGE = 33% X PARCEL AREA
 = 1.12(11,200) X 0.33
 = **4,219.4 SF**

ADU LOT COVERAGE = **800 SF**

ALLOWANCE = **2,944.75 SF**

TOTAL COVERAGE = **3,533 SF**

ALLOWANCE = **2,944.75 SF**

TOTAL COVERAGE = **3,533 SF**

KEY

AREA COUNTED FOR LOT COVERAGE BUT NOT FAR CALCULATIONS

AREA NOT COUNTED IN FAR CALCULATIONS

GARAGE

PROPOSED LOT COVERAGE


A	23'-6 1/4" x 21'-1/4"	494.5 SF
B	21'-0" x 10'-1 3/4"	343.5 SF
C	17'-2" x 30'-5 3/4"	523.25 SF
D	29'-3/4" x 15'-3/4"	437.75 SF
E	22'-1 3/4" x 10'-7 3/4"	244.75 SF
F	7'-1 1/4" x 16'-8 1/4"	117.5 SF
G	17'-3" x 21'-1 1/4"	364 SF
H	19'-0 3/4" x 18'-4 1/2"	367.5 SF
I	13'-7 1/4" x 3'-9"	51 SF
J	8'-2 1/2" x 3'-9"	23.25 SF
K	4'-7" x 4'-7"	21 SF
L	33'-7 3/4" x 15'-0"	518.75 SF
M	45'-0 1/4" x 45'-0"	2025 SF
COVERAGE		3,533 SF

PROPOSED FLOOR AREA


MAIN RESIDENCE MAIN LEVEL		
A	23'-6 1/4" x 21'-1/4"	494.5 SF
B	21'-0" x 10'-1 3/4"	343.5 SF
C	17'-2" x 30'-5 3/4"	523.25 SF
D	29'-3/4" x 15'-3/4"	437.75 SF
E	22'-1 3/4" x 10'-7 3/4"	244.75 SF
F	7'-1 1/4" x 16'-8 1/4"	117.5 SF
G	45'-0 1/4" x 45'-0"	2,025 SF
ADU		
CG	17'-3" x 21'-1 1/4"	364 SF
H	19'-0 3/4" x 18'-4 1/2"	367.5 SF
I	13'-7 1/4" x 3'-9"	51 SF
J	8'-2 1/2" x 3'-9"	23.25 SF
K	4'-7" x 4'-7"	21 SF
TOTAL MAIN LEVEL:		2,944.75 SF

MAIN RESIDENCE SECOND LEVEL

N	10'-9 3/4" x 6'-8 1/4"	72.25 SF
O	12'-8 1/2" x 4'-6 1/4"	57.5 SF
P	36'-9 1/4" x 6'-1 1/2"	237 SF
Q	7'-4 1/2" x 10'-5 3/4"	77.75 SF
R	18'-6 1/2" x 12'-5 3/4"	233 SF
S	34'-5 3/4" x 14'-2"	493.5 SF
T	17'-2" x 13'-10 3/4"	238.5 SF
SECOND LEVEL:		1,819.5 SF
TOTAL FAR:		4,764.25 SF

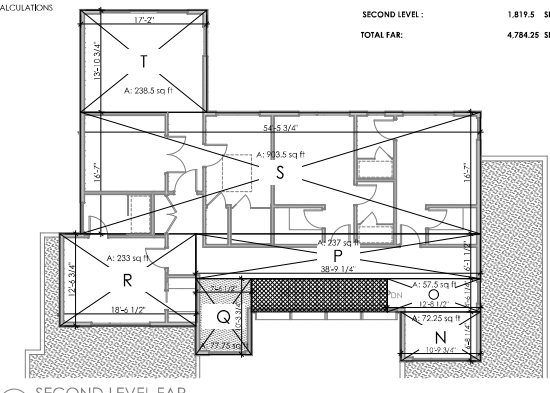

2 SECOND LEVEL FAR
1/8" = 1'-0"

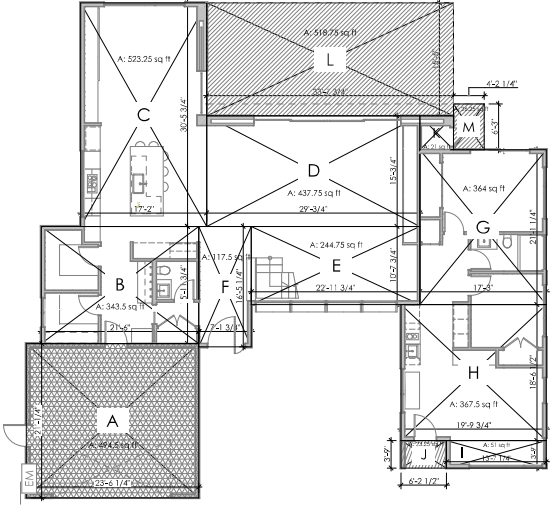


1 MAIN LEVEL FAR DIAGRAM
1/8" = 1'-0"



KRAMER RESIDENCE
 90 LA LOMA DRIVE
 MENLO PARK, CA 94025
 ana@awilliamson.com

DATE:	DATE:
USE PERMIT:	04/04/2022
DATE:	4/6/2022
SCALE:	2110
DRAWING TITLE:	FAR DIAGRAMS
SHEET:	A0.2

ANA WILLIAMSON ARCHITECT
 885 SANTA CRUZ AVE. A, MENLO PARK, CA 94025 T: (650) 325-4781

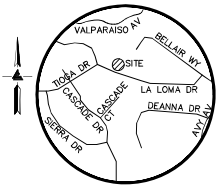

VICINITY MAP
NO SCALE


LEGEND AND NOTES

- BOUNDARY LINE
- - - BUILDING OVERHANG LINE
- - - ETC
- TV/T- ELECTRICAL/TELEPHONE/ CABLE TV OVERHEAD LINE
- TE/TE- TELEPHONE/CABLE TV OVERHEAD LINE
- E- ELECTRICAL OVERHEAD LINE
- T/E- ELECTRICAL/TELEPHONE/ OVERHEAD LINE
- CATV- CABLE TV OVERHEAD LINE
- X- FENCE LINE
- FLOW LINE
- SS SANITARY SEWER LINE
- A/C AIR CONDITIONING UNIT
- AD AREA DRAIN
- BFP BACK FLOW PREVENTER
- BW BENCHMARK
- BW BOTTOM OF RETAINING WALL
- BW BOTTOM OF WINDOW
- EB ELECTRICAL BOX
- EM ELECTRICAL METER
- FF FINISH FLOOR
- FF FIRE FLY
- FL FLOW LINE
- GM GAS METER
- GA GUY ANCHOR
- INV INVERT
- ICV IRRIGATION CONTROL VALVE
- JP JOINT POLE
- JP PILLAR, OR SIMILAR
- RP ROOF PEAK
- SSCO SANITARY SEWER CLEAN-OUT
- SSMH SANITARY SEWER MAINTENANCE HOLE
- TW TOP OF RETAINING WALL
- TOW TOP OF WINDOW
- TOS TOP OF SLAB
- WM WATER METER
- WV WATER VALVE
- XXX.XX SPOTGRADE

- ASPHALT
- BRICK
- CONCRETE
- POND/FOUNTAIN
- PAVERS
- RIVER ROCK
- STONE
- WOOD

LANDS OF CITY OF MENLO PARK

LANDS OF LE COCC

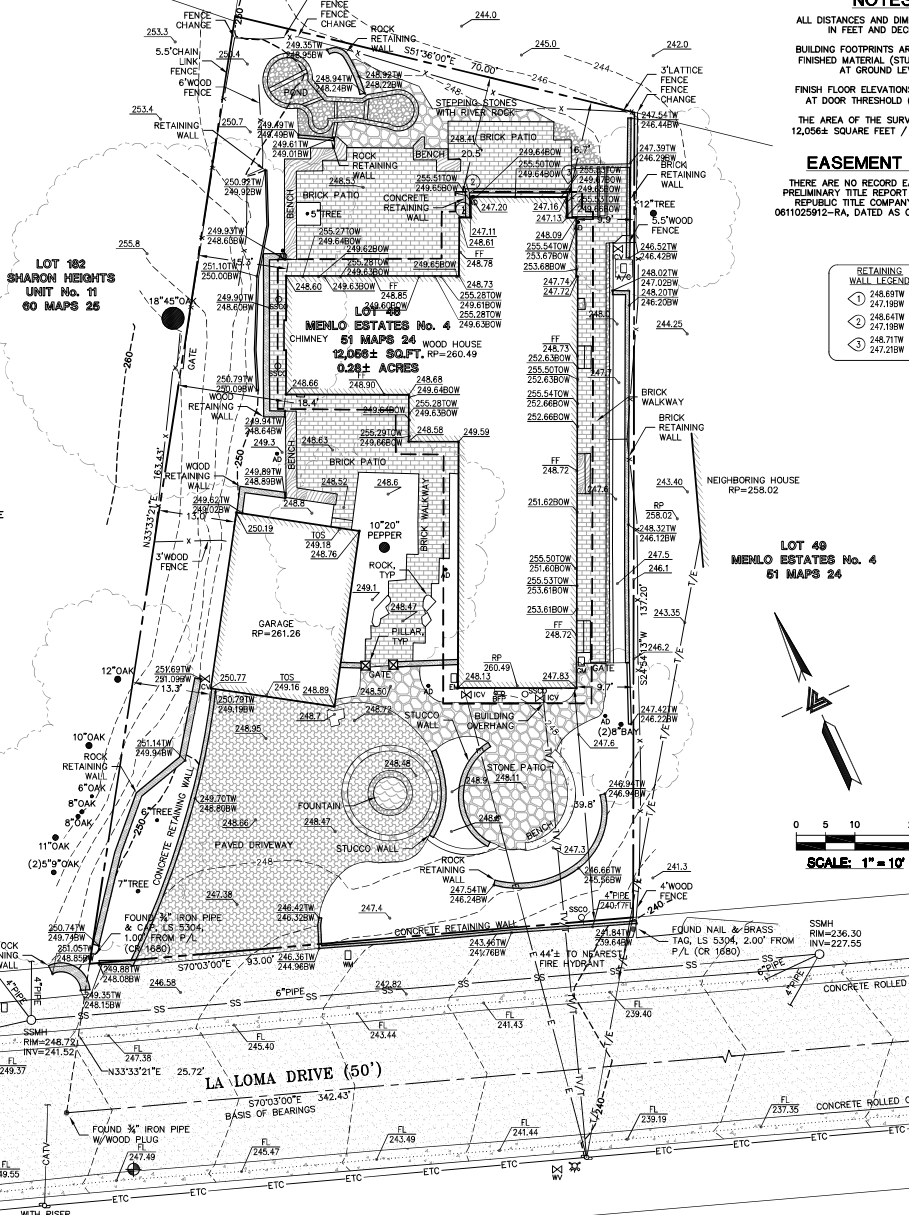

NOTES

ALL DISTANCES AND DIMENSIONS ARE IN FEET AND DECIMALS.
BUILDING FOOTPRINTS ARE SHOWN TO FINISHED MATERIAL (STUCCO/SIDING) AT GROUND LEVEL.
FINISH FLOOR ELEVATIONS ARE TAKEN AT DOOR THRESHOLD (EXTERIOR).
THE AREA OF THE SURVEYED LOT IS 12,056± SQUARE FEET / 0.28± ACRES

EASEMENT NOTE

THERE ARE NO RECORD EASEMENTS PER PRELIMINARY TITLE REPORT ISSUED BY OLD REPUBLIC TITLE COMPANY, ORDER NO. 0611025912-RA, DATED AS OF APRIL 21, 2021

BENCHMARK

CITY OF MENLO PARK BENCHMARK #5 BRASS DISC SET IN TOP OF CURB, STAMPED "CITY BENCHMARK #5" AT THE INTERSECTION OF SHARON PARK DRIVE AND MONTE ROSA DRIVE. ELEVATION = 232.56' (NAVD 88 DATUM)

SITE BENCHMARK

SURVEY CONTROL POINT MAG AND SHINER SET IN ASPHALT ELEVATION = 247.34' (NAVD 88 DATUM)

UTILITY NOTE

ALL UNDERGROUND PIPE TYPES, SIZES AND LOCATION SHOWN ON THIS SURVEY ARE BASED ON VISUAL OBSERVATION. ANY USE OF THIS INFORMATION SHOULD BE VERIFIED, BEFORE ITS USE, WITH THE CONTROLLING MUNICIPALITY OR UTILITY PROVIDER. THIS SURVEY MAKES NO GUARANTEE OF THE INSTALLED ACTUAL LOCATION, DEPTHS OR SIZE.

TREE NOTE

TREE SIZE, TYPE AND DRIFLINES ARE BASED ON A VISUAL OBSERVATION. FINAL DETERMINATION SHOULD BE MADE BY THE PROJECT ARBORIST.

FEMA FLOOD NOTE

PROPERTY COMPLETELY OUT OF SPECIAL FLOOD HAZARD AREA (SFHA)
FEMA FLOOD INSURANCE RATE MAP NO. 96081C0312E
EFFECTIVE DATE: OCTOBER 16, 2021


BASIS OF BEARINGS

THE BEARINGS SOUTH 70°03'00" EAST ALONG THE CENTERLINE OF LA LOMA DRIVE AS SHOWN ON THAT CERTAIN MAP ENTITLED "MENLO ESTATES NO. 4" FILED IN BOOK 51 OF MAPS AT PAGE 24, SAN MATEO COUNTY RECORDS, IS THE BASIS OF ALL BEARINGS SHOWN ON THIS MAP.

SURVEYOR'S STATEMENT

I CERTIFY THAT THIS PARCEL'S BOUNDARY WAS ESTABLISHED BY ME OR UNDER MY SUPERVISION AND IS BASED ON A FIELD SURVEY IN CONFORMANCE WITH THE LAND SURVEYOR'S ACT. ALL MONUMENTS ARE OF THE CHARACTER AND OCCUPY THE POSITIONS INDICATED AND ARE SUFFICIENT TO ENABLE THE SURVEY TO BE RETRACED.

GREGORY F. BRAZE DATE
L.S. NO. 7823

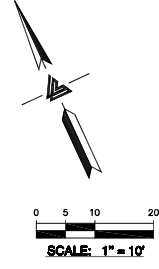

LEA & BRAZE ENGINEERING, INC.
CIVIL ENGINEER & LAND SURVEYORS
1000 CALIFORNIA STREET, SUITE 200
HAYWARD, CALIFORNIA 94545
(415) 887-6088
WWW.LEABRAZE.COM

90 LA LOMA DRIVE
MENLO PARK
CALIFORNIA

TOPOGRAPHIC SURVEY


REVISIONS	BY

JOB NO: 2211231
DATE: 8-19-21
SCALE: 1"=10'
BNDY BY: RM
FIELD BY: AG
DRAWN BY: ZB
SHEET NO:

SU1
1 OF 1 SHEETS

GRAPHIC LEGEND:

SYMBOL	DESCRIPTION
	(E) TREE TO REMAIN
	(E) TREE TO REMOVE

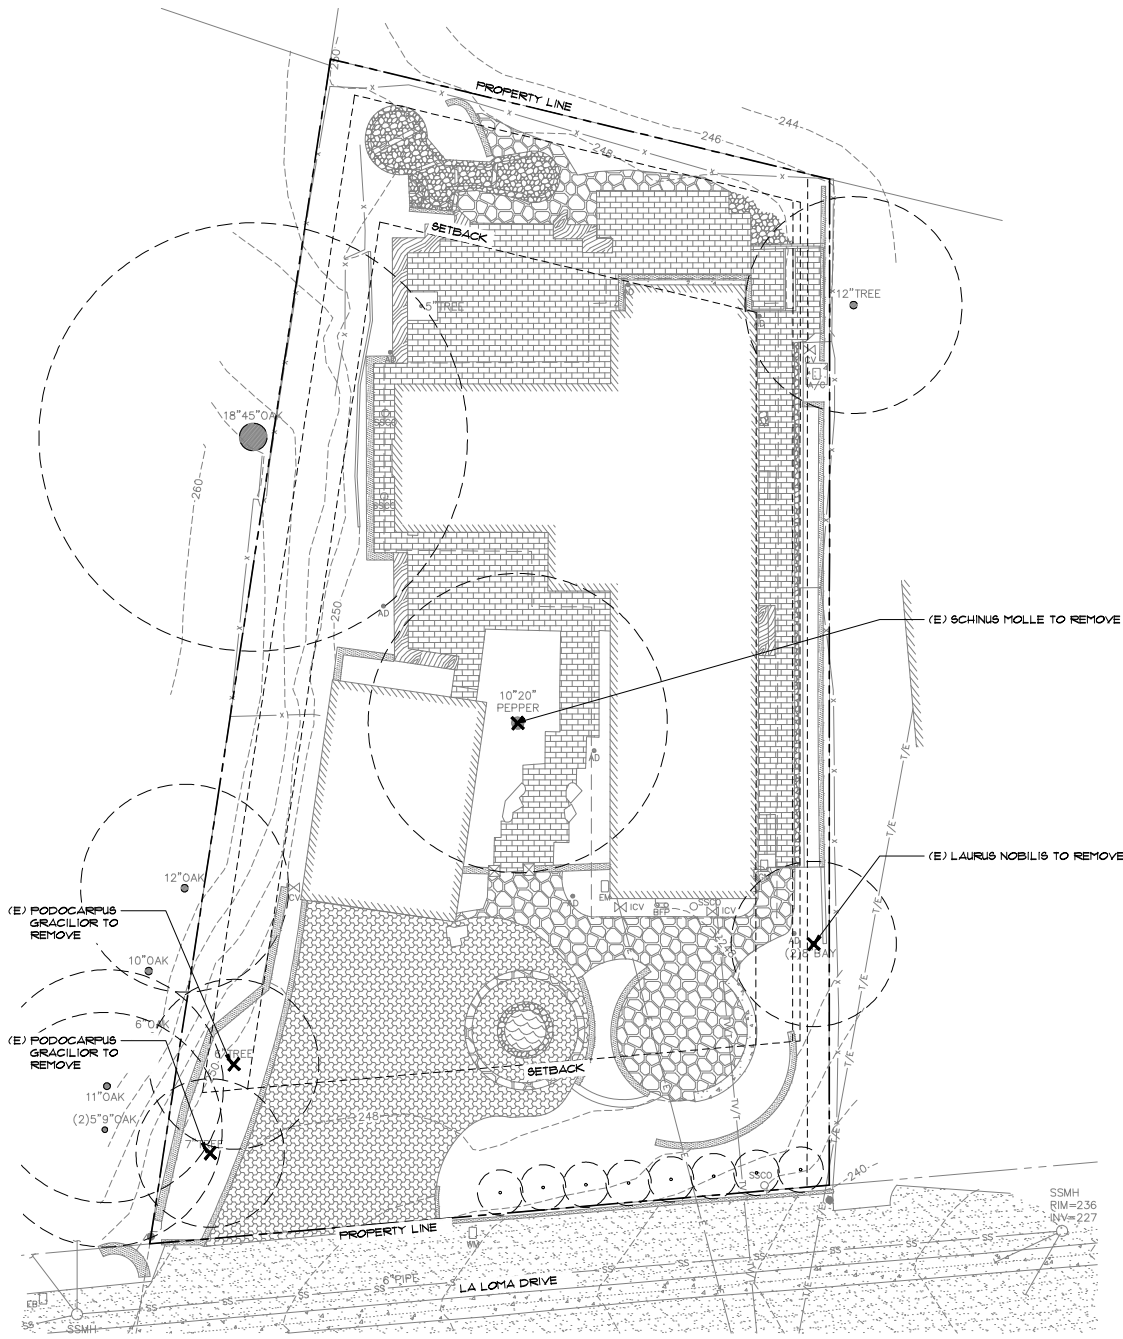

Keith Mills
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885 Santa Cruz Ave., Suite D.
Menlo Park, CA 94025
(P) 650.326.2294
(F) 650.326.2293
License #8561

KRAMER RESIDENCE
90 LA LOMA DRIVE, MENLO PARK, CALIFORNIA
APN: 074-150-470

PERMIT SET
TREE
INVENTORY
PLAN

scale: 1/8" = 1'-0"
date: 04/05/2022
drawn by: XA/PSWS
review by: KW
revision:

notes:
PROGRESS SET



SHEET NO.

L-0.1

1 of 3 SHEETS



SCALE: 1/8" = 1'-0"



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KRAMER RESIDENCE
90 LA LOMA DRIVE, MENLO PARK, CALIFORNIA
APN: 074-150-470

PERMIT SET

PLANTING PLAN

scale: 1/8" = 1'-0"
date: 04/05/2022
drawn by: XAPS/MS
review by: KW
revision:

notes:

PROGRESS SET



SHEET NO.

L-3.0

3 OF 3 SHEETS

PLANTING LIST:

SYMBOL	DESCRIPTION	COMMON NAME	SIZE	WIDTH	HEIGHT	WEL	QTY
TREES							
CS	CITRUS SANDSIS 'WASHINGTON'	NAVEL ORANGE	24" BOX	8'-15"	8'-15"	MED	1
CL	CITRUS LIMON 'MEYER IMPROVED'	LEMON 'IMPROVED MEYER'	24" BOX	12"	8'-10"	MED	1
ED	ERIOBOTRYA DEFLEXA	BRONZE LOGANET	24" BOX	15'-25"	15'-25"	MED	1
PA	FRUNUS ARMENIACA 'BLEHNEM'	BLEHNEM APRICOT	24" BOX	6'-10"	12'-18"	LOW	1
PM	PODOCARPUS MACROPHYLLUS	YEW PINE	15 GAL	6"	15"	MED	13
FP	FRUNUS PERSICA 'FROST'	FROST PEACH	24" BOX	15'-30"	15'-30"	LOW	1
FC	ROUS CARICA 'IMPROVED BROWN TURKEY'	BROWN TURKEY FIG	24" BOX	10'-25"	10'-25"	MED	1

GROUNDCOVER / SHRUBS

AA	ASPARAGUS AETHIOPICUS	SFRENGER'S ASPARAGUS	5 GAL	4"	3"	MED	10
AC	ACACIA COGNATA COUSIN ITT	COUSIN ITT ACACIA	5 GAL	4'-6"	2'-3"	LOW	8
AF	ANGONANTHOS FLAVIDUS	KANGAROO PAU	5 GAL	2'-4"	3'-6"	LOW	11
AS	ACHILLEA MILLEFOLIUM 'SALMON BEAUTY'	SALMON YARROW	1 GAL	2'-3"	1'-2"	LOW	1
BM	BOUGAINVILLEA 'MONTH'	PURPLE QUEEN BOUGAINVILLEA	5 GAL	6'-10"	15"	LOW	1
CC	CARIPENTERIA CALIFORNICA	BUSH ANEMONE	1 GAL	10"	6'-10"	MED	4
CE	CHONDROPETALUM ELEPHANTINUM	LARGE CAPE RUSH	5 GAL	4'-6"	3'-5"	LOW	3
DO	DAPHNE ODORA	FRAGRANT DAPHNE	5 GAL	2'-4"	3'-6"	LOW	3
EA	ECHVEVERIA 'AFTERGLOW'	AFTERGLOW ECHEVERIA	1 GAL	1'-2"	1'-2"	LOW	5
EC	EPILIBIUM CANUM CALISTOGA	CALIFORNIA RUCHISA	1 GAL	2'-3"	1'-2"	LOW	15
ER	EUPHORBIA RIGIDA	UPRIGHT MYRTLE SPURGE	1 GAL	2'	1'-2"	LOW	8
HH	HELLEBORE HYBRID	HYBRID LENTEN ROSE	1 GAL	2'	15'-2"	LOW	21
IR	IRIS DOUGLASSIANA	DOUGLAS IRIS	1 GAL	2'-4"	6'-2.5"	LOW	3
LC	LEUCADENDRON CORDFOLIUM	WOODING PINUSHION	5 GAL	4'-6"	5'-6"	LOW	6
LM	LEUCADENDRON 'HAU SUNSET'	PROTEACEAE LEUCADENDRON HYBRID	5 GAL	4'-6"	4'-6"	LOW	14
LN	LIPPIA NODIFLORA 'CAMPAGNA VERDE'	KURAPIA	4"	SREADING	2'	LOW	12350FT
MC	MULLEBERGIA CAPILLARIS 'LENCA'	PINK HUMULY GRASS	1 GAL	3"	4"	LOW	16
PM	PENSTEMON MARGARITA BOP	BEARDTONGUE	1 GAL	2'	2'	LOW	15
SA	SEDUM RUPESTRE 'ANGELINA'	STONECROP	1 GAL	2'-3"	6"	LOW	4
SB	SALVIA X SYLVESTRIS 'BLUE HILL'	WOOD SAGE 'BLUE HILL'	1 GAL	1'-2"	1'-2"	LOW	24
SB	SENECIO BERPENS	BLUE CHALKSTICKS	1 GAL	2'-3"	1'	LOW	1
TL	TRICHOSTEMA LANATUM	WOOLY BLUECURLS	1 GAL	4"	4"	VERY LOW	6
WF	WOODWARDIA FIBRATA	GIANT CHAIN FERN	5 GAL	4'-6"	4'-6"	MED	5

EXISTING TREE LEGEND:

SYMBOL	DESCRIPTION
(E) TREE TO REMAIN	
PROPERTY LINE	

I HAVE COMPLIED WITH THE CRITERIA OF THE WATER EFFICIENT LANDSCAPE ORDINANCE AND APPLIED THEM FOR THE EFFICIENT USE OF WATER IN THE LANDSCAPE AND IRRIGATION DESIGN PLAN.


SIGNATURE: *Keith Willig* DATE: 03-08-22

Keith Willig
Landscape Architecture, LLC #5851
Contractor C-21 Lic#102067

A LANDSCAPE IRRIGATION AUDIT IS REQUIRED. THIS AUDIT MUST BE COMPLETED BY A CERTIFIED LANDSCAPE IRRIGATION AUDITOR NOT THE DESIGNER OR INSTALLER. THE AUDIT MUST BE SUBMITTED TO THE BUILDING DEPARTMENT WITH A CERTIFICATE OF COMPLETION (APPENDIX G) AS REQUIRED BY THE DEPARTMENT OF WATER RESOURCES PRIOR TO SCHEDULING A FINAL INSPECTION OF THE WATER EFFICIENT LANDSCAPE PERMIT.

PLANTING NOTES:

- CONTRACTOR SHALL BE RESPONSIBLE FOR MAKING HIMSELF FAMILIAR WITH ALL EASEMENTS, UNDERGROUND UTILITIES, PIPES AND STRUCTURES. CONTRACTOR SHALL TAKE SOLE RESPONSIBILITY FOR ANY COST INCURRED DUE TO DAMAGE OF SAID UTILITIES.
- DO NOT WILLFULLY PROCEED WITH CONSTRUCTION AS DESIGNED WHEN IT IS OBVIOUS THAT UNKNOWN OBSTRUCTIONS, AREA DISCREPANCIES AND/OR GRADE DIFFERENCES EXIST THAT MAY NOT HAVE BEEN KNOWN DURING DESIGN. SUCH CONDITIONS SHALL BE IMMEDIATELY BROUGHT TO THE ATTENTION OF THE OWNER. THE CONTRACTOR SHALL ASSUME FULL RESPONSIBILITY FOR ALL NECESSARY REVISIONS DUE TO FAILURES TO GIVE SUCH NOTIFICATION.
- LANDSCAPE AREAS SHALL DRAIN AWAY FROM ALL BUILDINGS AND FACILITIES AT 2% MIN FOR 3' AS PER DRAINAGE PLAN. FOLLOW ALL DRAINAGE PLANS.
- ALL PLANT MATERIAL SHALL BE OF NURSERY QUALITY AND BE GUARANTEED FOR THREE MONTHS.
- ALL PLANT MATERIAL SHALL BE APPROVED FOR QUALITY BY THE OWNER AND/OR LANDSCAPE ARCHITECT PRIOR TO INSTALLATION.
- FINAL LOCATION OF ALL PLANT MATERIAL SHALL BE SUBJECT TO THE APPROVAL OF THE OWNER.
- SOIL PREPARATION:
ROTOTILL THE FOLLOWING AMENDMENTS 6" INTO THE SOIL AT RATES INDICATED PER 1000 SQUARE FEET FOR ALL PLANTING AREA AND 500 AREAS:
 - 6 CUBIC YARDS NITROGEN STABILIZED BARDNET OR EQUAL
 - 15 LBS GROUNDPOWDER PLUS OR EQUAL FREE PLANT FERTILIZER
 - A SITE SPECIFIC SOIL ANALYSIS SHOULD BE FOLLOWED BY CONTRACTOR PER WELD REQUIREMENT.
 - PLANT PITS SHALL BE 2X THE ROOT BALL SIZE WITH 10% NATIVE SOIL AND 30% AMENDMENTS WITH PLANT TABLETS OR OTHER FREE PLANT FERTILIZER.
 - ALL PLANTS SHALL HAVE A 2" PIN WATERING BERRY AROUND THEM.
 - TREES ARE TO BE STAKED WITH A MIN. 2"X2" X REQUIRED HEIGHT STAKE AND TIED TO INSURE VERTICAL GROWTH.
 - ALL PLANTING AREAS SHALL BE WATERED WITH AN AUTOMATIC IRRIGATION SYSTEM.
 - ALL APPLICABLE CODES TO BE FOLLOWED. ALL WORK REQUIRING PERMITS SHALL HAVE PERMITS BEFORE WORK IS TO BEGIN.
 - ALL PLANTING AREAS TO BE COVERED WITH 2" THICK LAYER OF FREEMULCH ARBOR MULCH.
 - ALL TREE ROOTS GREATER THAN 1/2" IN DIAMETER DAMAGED DURING CONSTRUCTION SHALL BE CUT CLEAN AND SEALED.
 - CONTRACTOR TO VERIFY QUANTITIES. QUANTITIES SHOWN ARE FOR REFERENCE ONLY.
 - A MINIMUM 3" LAYER OF MULCH SHALL BE APPLIED ON ALL EXPOSED SOIL SURFACES OF PLANTING AREAS EXCEPT TURF AREAS, CREEPING OR ROOTING GROUNDCOVERS OR DIRECT SEEDING APPLICATIONS WHERE MULCH IS CONTRAINDICATED.
 - 1% FOR SOILS LESS THAN 6% ORGANIC MATTER IN THE TOP 6" OF SOIL. COMPOST AT A RATE OF 1/4" PER 1000 SQUARE YARDS PER 1000 SQUARE FEET OF FERTILIZABLE AREA SHALL BE INCORPORATED TO A DEPTH OF 6" INTO THE SOIL.
 - TURF SHALL NOT EXCEED 25% OF THE LANDSCAPE AREA IN RESIDENTIAL AREA.

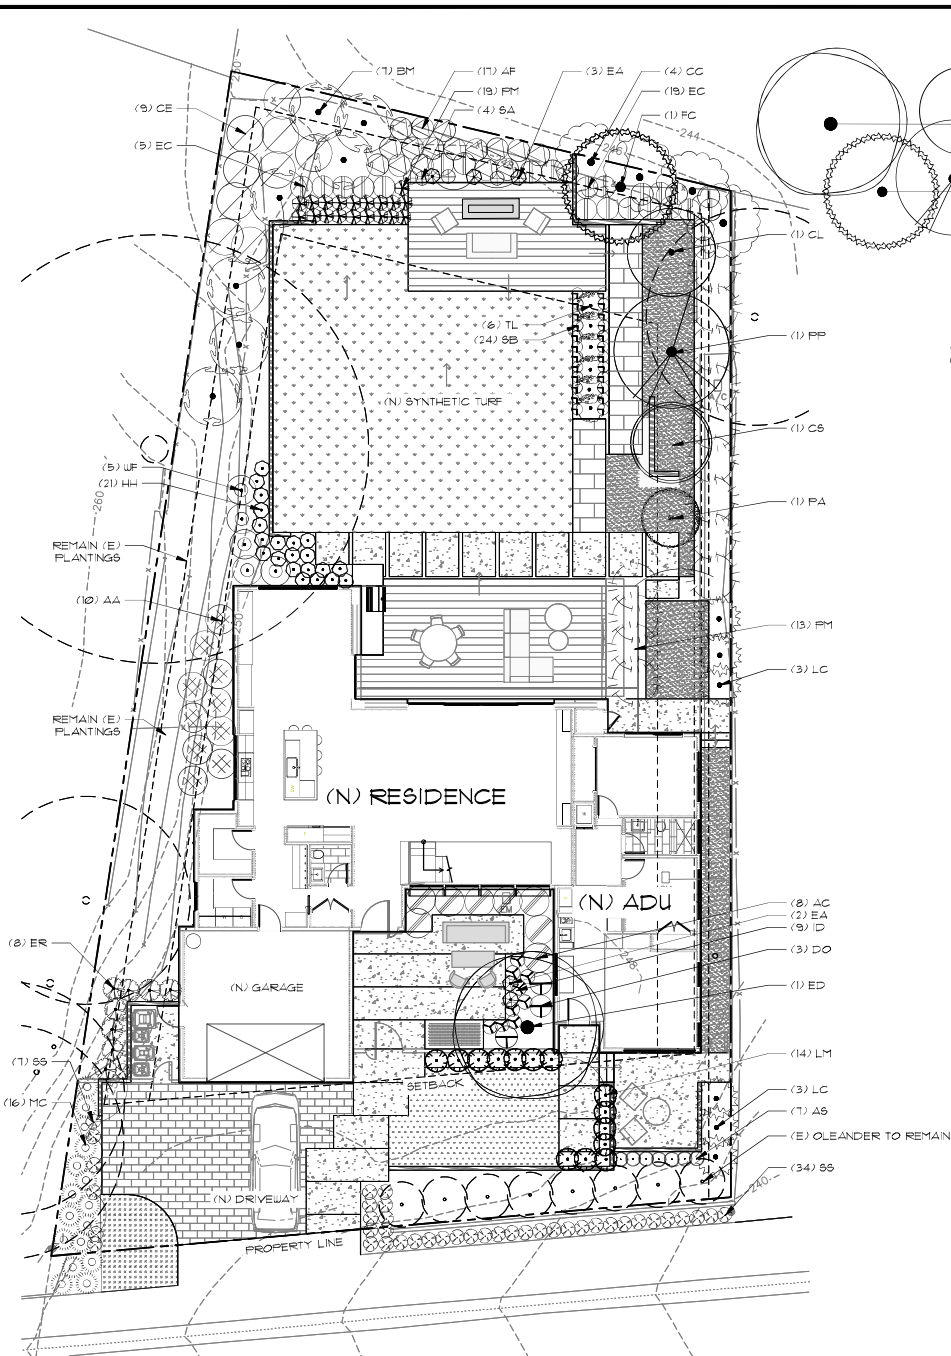


SITE ANALYSIS

ZONING:	RI-5
LOT AREA:	12,056 SF
ALLOWABLE FLOOR AREA:	4,064 SF + 800 SF (ADU) 2,800 + 235 (12,056 x 1.00)
TOTAL PROPOSED FLOOR AREA:	4,784.25 SF
PROPOSED FIRST FLOOR AREA:	2,182.25 SF
PROPOSED SECOND FLOOR AREA:	1,819.5 SF
PROPOSED ADU FLOOR AREA:	782.5 SF
LAND COVERAGE:	29.3% (22.81% MAIN RESIDENCE + 6.49% ADU) 3.5335(27.50 SF MAIN RESIDENCE + 792.5 SF ADU)
LANDSCAPING:	44.8% (ALL PERVIOUS AREA)
PAVED SURFACES:	55.2% (ALL IMPERVIOUS AREA)
PARKING SPACES:	2 COVERED SPACES

SITE PLAN

1/8" = 1'-0"

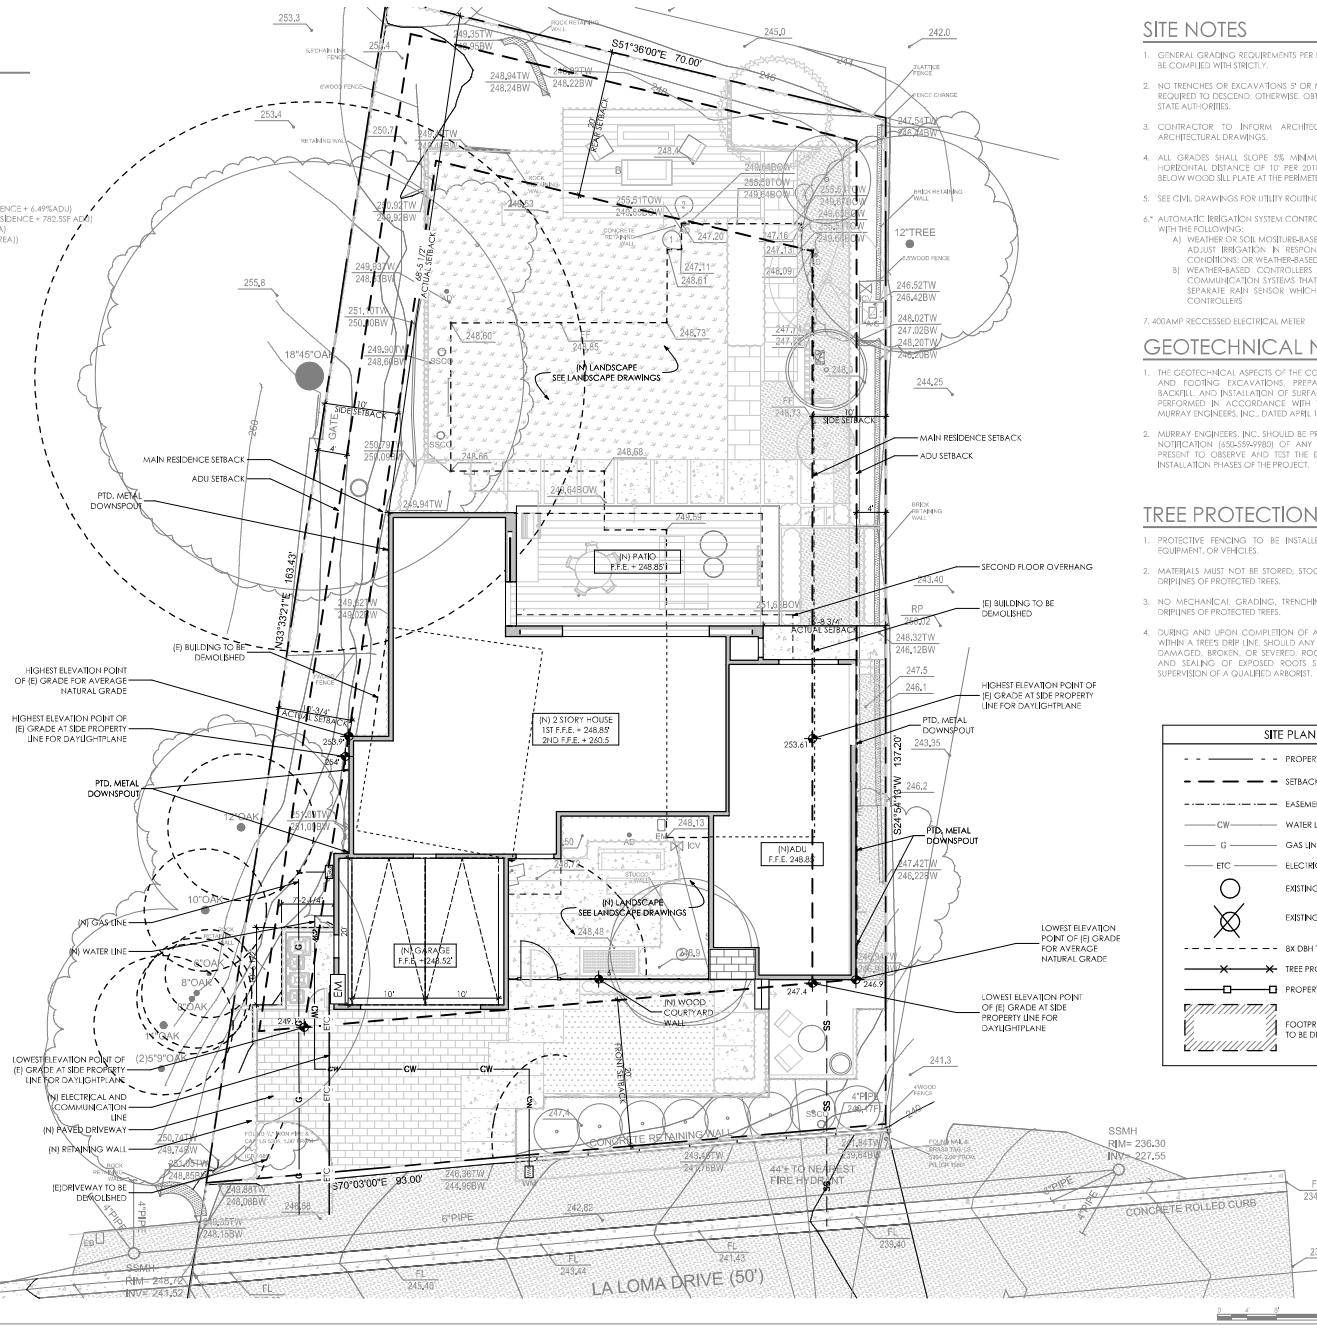

SITE NOTES


- GENERAL GRADING REQUIREMENTS PER LOCAL GOVERNING JURISDICTIONS SHALL BE COMPLIED WITH STRICTLY.
- NO TRENCHES OR EXCAVATIONS 5' OR MORE IN DEPTH INTO WHICH A PERSON IS REQUIRED TO DESCEND, OTHERWISE, OBTAIN NECESSARY PERMIT FROM LOCAL OR STATE AUTHORITIES.
- CONTRACTOR TO INFORM ARCHITECT OF ANY DISCREPANCIES BETWEEN ARCHITECTURAL DRAWINGS.
- ALL GRADES SHALL SLOPE 5% MINIMUM AWAY FROM THE BUILDING FOR A HORIZONTAL DISTANCE OF 10' PER 2016 CEC 401.4 AND BE A MINIMUM OF 8" BELOW WOOD SILL PLATE AT THE PERIMETER OF THE BUILDING.
- SEE CIVIL DRAWINGS FOR UTILITY ROUTING.
- AUTOMATIC IRRIGATION SYSTEM CONTROLLERS FOR LANDSCAPING SHALL COMPLY WITH THE FOLLOWING:
 - A) WEATHER OR SOIL MOISTURE-BASED CONTROLLERS THAT AUTOMATICALLY ADJUST IRRIGATION IN RESPONSE TO CHANGES IN WEATHER OR SOIL CONDITIONS OR WEATHER-BASED CONTROLLERS.
 - B) WEATHER-BASED CONTROLLERS WITHOUT INTEGRAL RAIN SENSORS OR COMMUNICATION SYSTEMS THAT ACCOUNT FOR RAINFALL SHALL HAVE A SEPARATE RAIN SENSOR WHICH CONNECTS OR COMMUNICATES WITH CONTROLLERS.
- 400AMP RECESSED ELECTRICAL METER

GEOTECHNICAL NOTES

- THE GEOTECHNICAL ASPECTS OF THE CONSTRUCTION, INCLUDING SITE GRADING, PER AND FOOTING EXCAVATIONS, PREPARATION OF SUBGRADE, RETAINING WALL BACILLI, AND INSTALLATION OF SURFACE AND SUBSURFACE DRAINAGE SHOULD BE PERFORMED IN ACCORDANCE WITH THE GEOTECHNICAL REPORT PREPARED BY MURRAY ENGINEERS, INC. DATED APRIL 1, 2015.
- MURRAY ENGINEERS, INC. SHOULD BE PROVIDED WITH AT LEAST 48 HOURS ADVANCE NOTIFICATION (555-559-9789) OF ANY EARTHWORK OPERATIONS AND SHOULD BE PRESENT TO OBSERVE AND TEST THE EARTHWORK, FOUNDATION, AND DRAINAGE INSTALLATION PHASES OF THE PROJECT.

TREE PROTECTION NOTES


- PROTECTIVE FENCING TO BE INSTALLED PRIOR TO ARRIVAL OF MATERIALS, EQUIPMENT, OR VEHICLES.
- MATERIALS MUST NOT BE STORED, STOCKPILED, DUMPED, OR BURIED INSIDE THE DRIP LINES OF PROTECTED TREES.
- NO MECHANICAL GRADING, TRENCHING, OR SURFACE SCRAMING INSIDE THE DRIP LINES OF PROTECTED TREES.
- DURING AND UPON COMPLETION OF ANY TRENCHING & GRADING OPERATION WITHIN A TREE'S DRIP LINE, SHOULD ANY ROOTS GREATER THAN 1" IN DIAMETER BE DAMAGED, BROKEN, OR SEVERED, ROOT PRUNING TO INCLUDE FLUSH CUTTING AND SEALING OF EXPOSED ROOTS SHOULD BE ACCOMPLISHED UNDER THE SUPERVISION OF A QUALIFIED ARBORIST.

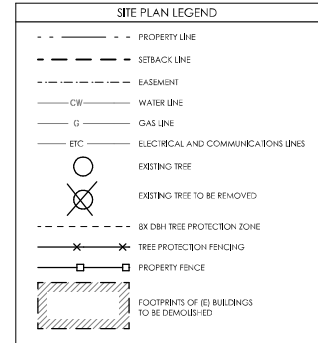


KRAMER RESIDENCE
90 LA LOMA DRIVE
MENLO PARK, CA 94025
APR 07/2022

DATE:	04/04/2022
USE PERMIT:	
DATE:	4/6/2022
DATE:	2110
DRAWING NO.:	PROPOSED SITE PLAN
DATE:	TV
DATE:	4/6/2022
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DATE:	TV
DATE:	4/6/2022
DATE:	2110
DRAWING NO.:	PROPOSED SITE PLAN


SHEET: **A1.1**

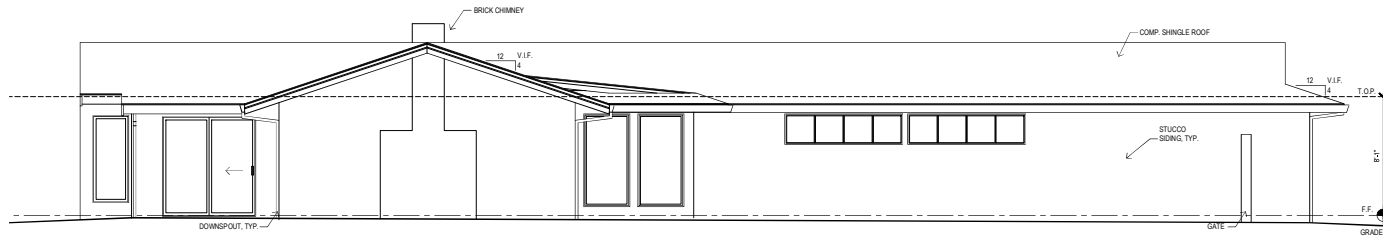


4 EXISTING LEFT / WEST ELEVATION - TO BE DEMOLISHED
1/4" = 1'-0"

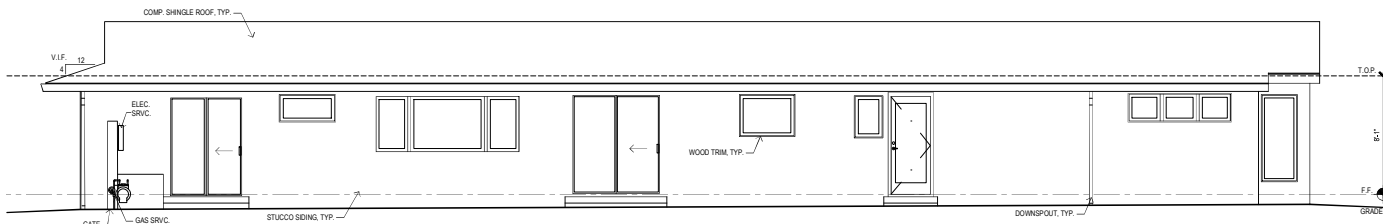

3 EXISTING RIGHT / EAST ELEVATION - TO BE DEMOLISHED
1/4" = 1'-0"

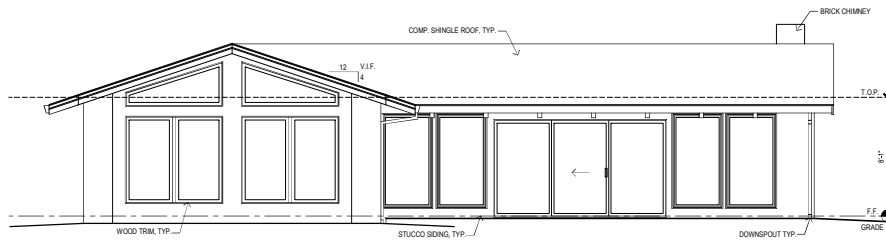

2 EXISTING BACK / NORTH ELEVATION - TO BE DEMOLISHED
1/4" = 1'-0"

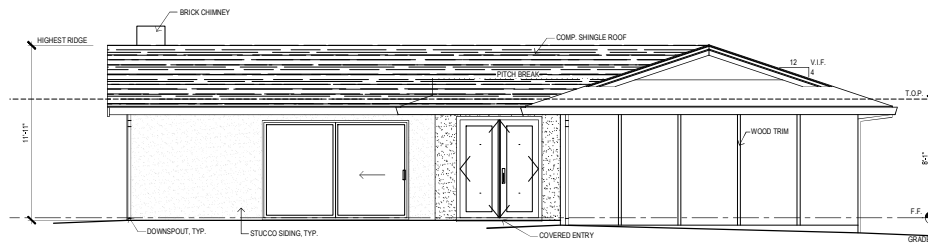

1 EXISTING FRONT / SOUTH ELEVATION - TO BE DEMOLISHED
1/4" = 1'-0"



ANA WILLIAMSON ARCHITECT
885 SANTA CRUZ AVE. A, MENLO PARK, CA 94025 T. (650) 320-0577 F. (650) 325-4751



KRAMER RESIDENCE
90 LA LOMA DRIVE
MENLO PARK, CA 94025
AWA 01-04-18-010

FILE: 04/04/2022

USE PERMIT: 04/04/2022

DATE: 4/6/2022

SCALE: 2110

DRAWING TITLE: EXISTING ELEVATIONS TO BE DEMOED

SHEET: A3.0

DATE: 4/6/2022

SCALE: 2110

DRAWING TITLE: EXISTING ELEVATIONS TO BE DEMOED

SHEET: A3.0

DATE: 4/6/2022

SCALE: 2110

DRAWING TITLE: EXISTING ELEVATIONS TO BE DEMOED

SHEET: A3.0

DATE: 4/6/2022

SCALE: 2110

DRAWING TITLE: EXISTING ELEVATIONS TO BE DEMOED

SHEET: A3.0

DATE: 4/6/2022

SCALE: 2110

DRAWING TITLE: EXISTING ELEVATIONS TO BE DEMOED

SHEET: A3.0




ANA WILLIAMSON ARCHITECT
885 SANTA CRUZ AVE. A, MENLO PARK, CA 94025 T. (650) 320-6577 F. (650) 325-4781




KRAMER RESIDENCE
90 LA LOMA DRIVE
MENLO PARK, CA 94025
ANA WILLIAMSON ARCHITECT

DATE	04/06/2022
USE PERMIT	
DATE	4/6/2022
SCALE	2110
DRAWING TITLE	PROPOSED ELEVATIONS

SHEET: **A3.2**

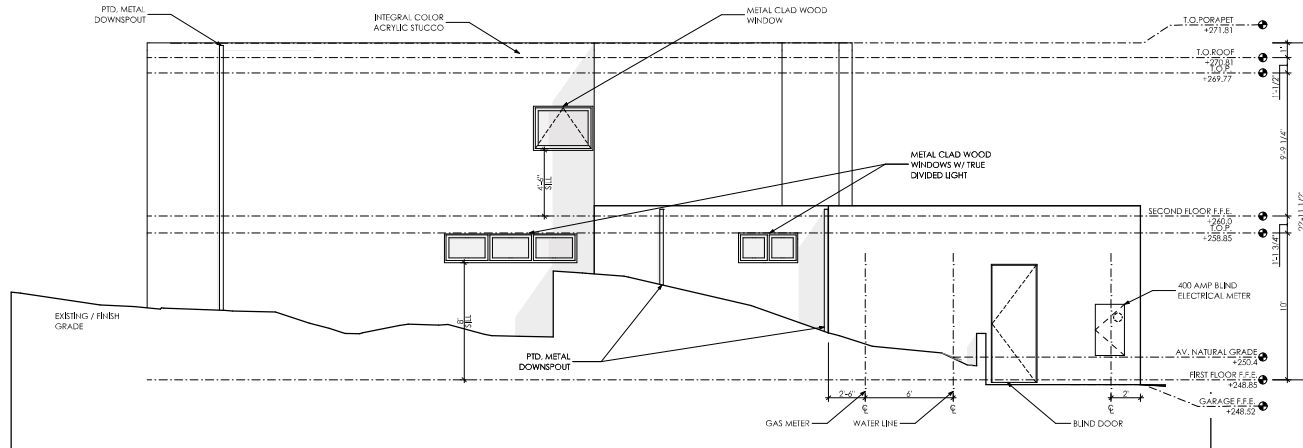

4 PROPOSED LEFT/WEST ELEVATION
1/4" = 1'-0"

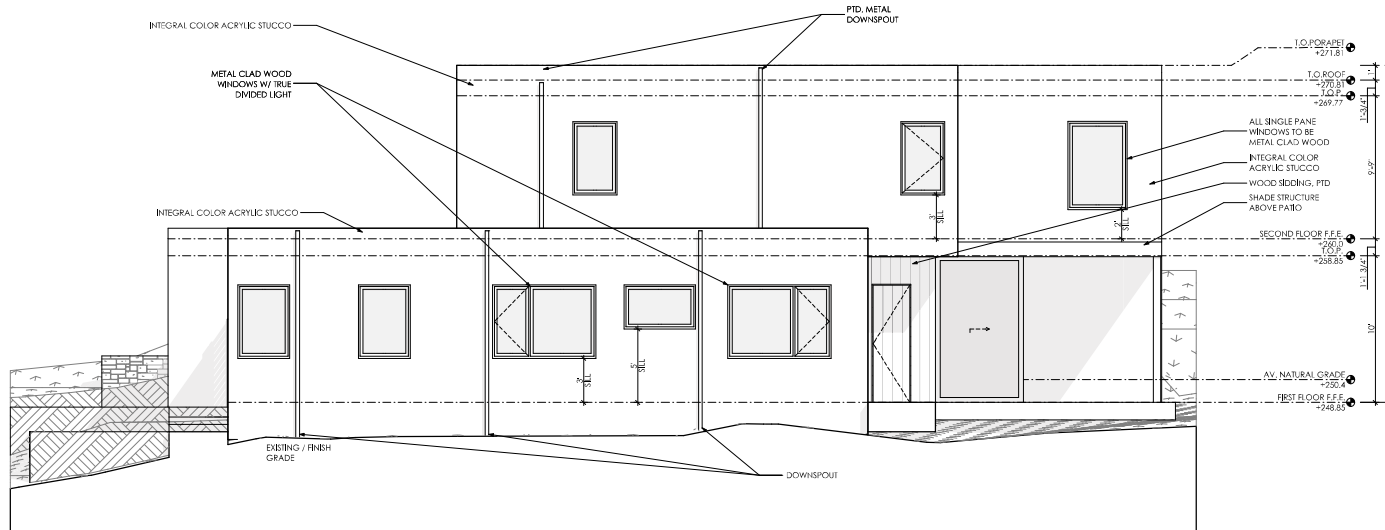

3 PROPOSED RIGHT/EAST ELEVATION
1/4" = 1'-0"

