**Subject:** Reguest for Variance – 108 Blackburn Avenue

## **Dear Planning Department,**

We are writing to formally request a variance for the property located at 108 Blackburn Avenue. Due to unforeseen circumstances related to FEMA compliance, we are seeking approval to reconstruct the left-side wall of the residence in its original location.

## **Background**

The property is a substandard lot measuring 55 feet in width and 99 feet in depth, situated in the R-1-U zoning district. Under zoning regulations, the required side setback is 10% of the lot width, with a minimum of five feet and a maximum of 10 feet. In this case, the required setback is 5.5 feet. The original structure included a nonconforming wall on the left side, which was located 5 feet from the property line.

On March 25, 2024, the Planning Commission approved a use permit for remodeling and the addition of first and second-story expansions to the existing nonconforming, single-story residence. This approval was granted with the condition that the project would not increase the nonconformity of the left-side wall.

Additionally, the property is located within Flood Zone AE and is subject to Menlo Park's Flood Damage Prevention Ordinance, which aligns with FEMA Technical Bulletins and the latest state and national building codes. Because the scope of work qualifies as a FEMA-designated substantial improvement, all materials below the Design Flood Elevation (DFE) must be resistant to flood damage, per FEMA's guidelines.

### **Current Status and Justification for Variance**

During construction, we discovered that in order to meet FEMA's floodproofing requirements, all materials below the DFE had to be replaced with flood-resistant materials (such as pressure-treated wood, redwood, or concrete). This requirement necessitated the demolition of all existing walls below the DFE, including the nonconforming left-side wall.

To confirm this requirement, we reached out to the city's flood management department and received the following response:

"Regarding any existing materials below the DFE (53.7'), they are required to be brought into compliance with current NFIP standards, including the requirement that they be flood-damage resistant (i.e., pressure-treated, redwood, concrete, etc.)."

Given this directive, the demolition of the left-side wall was unavoidable in order to bring the structure into compliance with FEMA and Menlo Park's Flood Damage Prevention Ordinance.

We are requesting a variance to allow the left-side wall to be reconstructed in its original location, utilizing the existing, intact foundation. The proposed reconstruction will not extend beyond the previous footprint or increase nonconformity in any way. This request arises from an exceptional situation where adherence to FEMA regulations directly conflicts with zoning requirements related to nonconforming structures.

### Conclusion

We respectfully ask for the Planning Department's consideration in granting this variance, as it would allow us to comply with both flood mitigation standards and local zoning regulations in the most practical manner. We appreciate your time and consideration and welcome any opportunity to discuss this matter further.

Attached to this letter are the planning commission approval letter, evidence for the required findings to grant variance, email communication with flood management, and Menlo Park's Flood Damage Prevention Ordinance.

Please let us know if additional information is required.

## Sincerely,

Lavan Construction and Vahid Taslimitehrani/Haleh Dolati (property owners)

# **Findings**

1. That a hardship peculiar to the property and not created by any act of the owner exists. In this context, personal, family or financial difficulties, loss of prospective profits and neighboring violations are not hardships justifying a variance. Further, a previous variance can never have set a precedent, for each case must be considered only on its individual merits:

The hardship arises from the property's location within Flood Zone AE, which subjects it to FEMA regulations requiring flood-resistant materials below the Design Flood Elevation (DFE). The requirement to replace these materials necessitated the demolition of the nonconforming left-side wall. This is a hardship unique to the property due to its flood zone designation, and it was not created by any act of the owner. Instead, it results from federal and local flood protection regulations that must be followed to ensure the property's compliance and safety.

2. That such variance is necessary for the preservation and enjoyment of substantial property rights possessed by other conforming property in the same vicinity and that a variance, if granted, would not constitute a special privilege of the recipient not enjoyed by his/her neighbors.

The requested variance would not grant a special privilege but rather restore the pre-existing condition of the home in compliance with necessary floodproofing regulations. Other properties in the vicinity that do not fall under the same flood zone restrictions are not subject to this hardship. Granting the variance allows the property owner to maintain a functional residence without expanding nonconformity beyond what existed before the necessary demolition.

3. That the granting of the variance will not be materially detrimental to the public health, safety, or welfare, or will not impair an adequate supply of light and air to adjacent property.


Rebuilding the left-side wall in its original location will not impact public health or safety, as it aligns with FEMA flood protection measures. The setback remains unchanged from its previous condition, ensuring no new obstruction to neighboring properties' light or air supply. Additionally, adherence to flood-resistant construction materials enhances overall property safety, benefiting the broader community.


4. That the conditions upon which the requested variance is based would not be applicable, generally, to other property within the same zoning classification.


This variance request is specific to 108 Blackburn Avenue due to its location within Flood Zone AE and the subsequent FEMA compliance requirements for Substantial Improvements (SI). Other properties in the same zoning district that are not within a flood zone would not face the same mandate to replace materials below the DFE, making this an uncommon situation rather than a broadly applicable condition.

5. That the condition upon which the requested variance is based is an unusual factor that was not anticipated or discussed in detail during any applicable Specific Plan process.

The conflict between FEMA's floodproofing requirements for Substantial Improvements (SI) and Menlo Park's zoning restrictions for nonconforming structures is an unusual and unforeseen circumstance. While the Planning Commission approved the remodeling with the condition that nonconformity would not increase, the necessity to demolish the wall to comply with flood regulations was not fully anticipated. This situation was not explicitly discussed in prior planning considerations, making the variance necessary to reconcile regulatory conflicts.

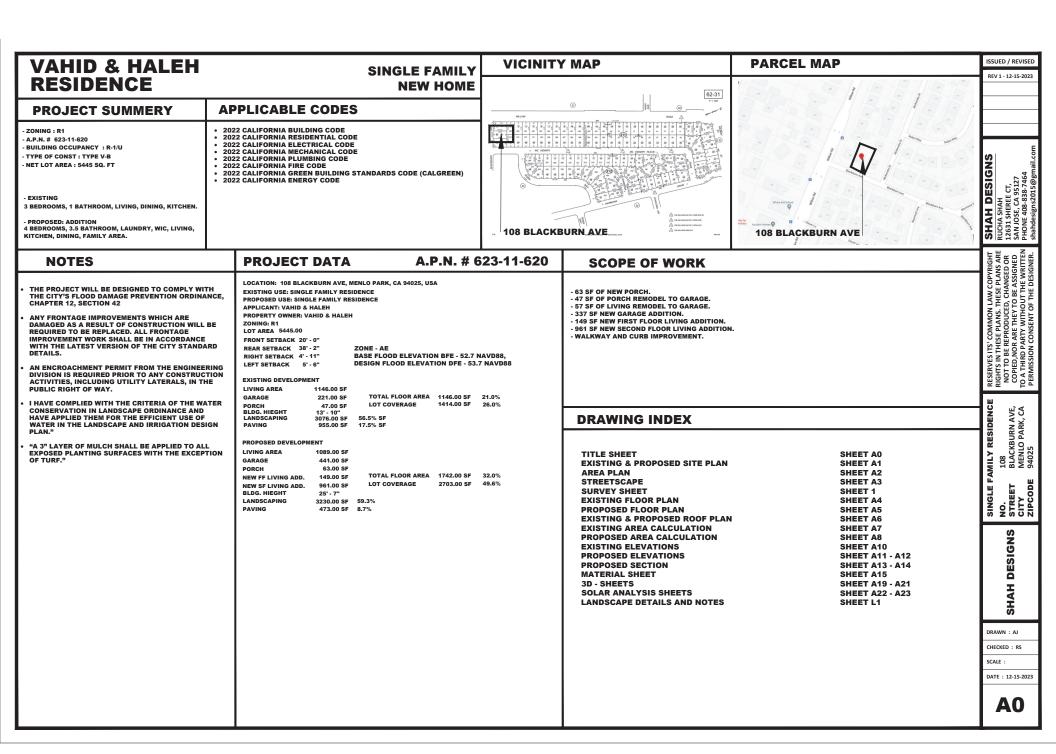

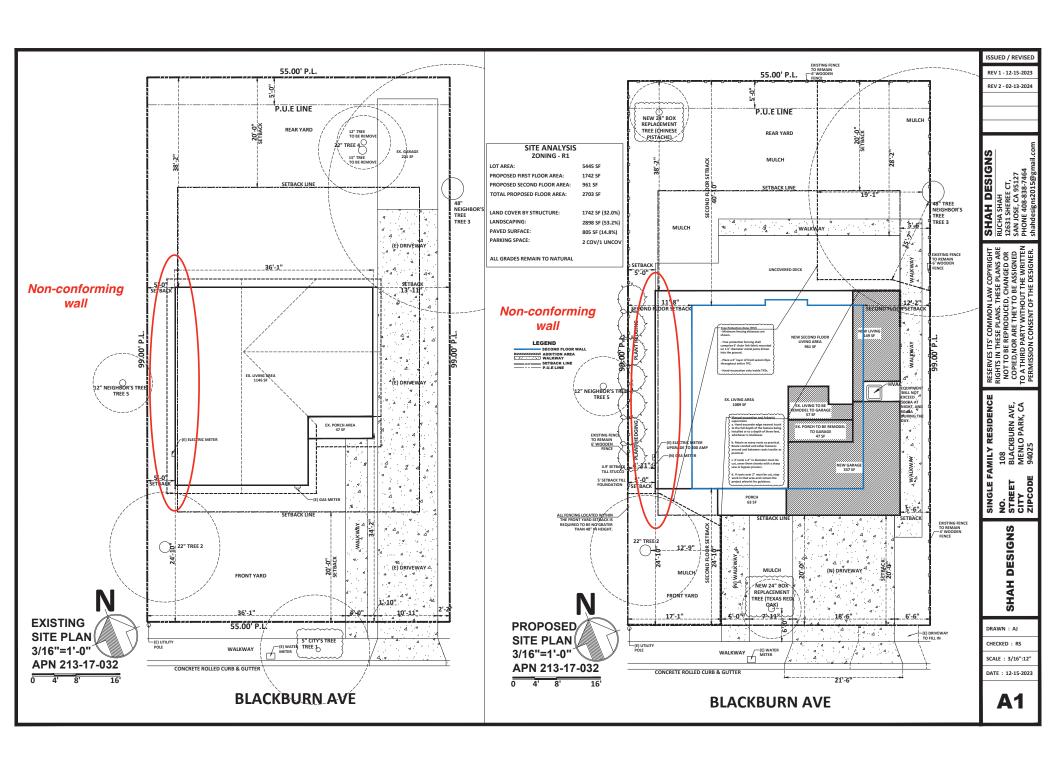

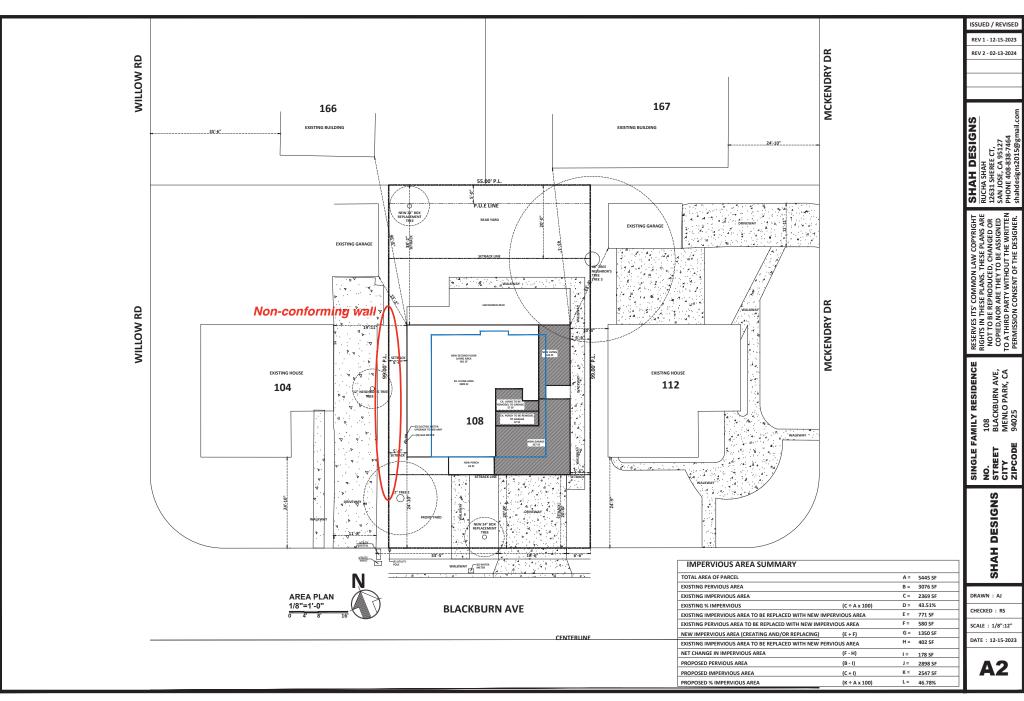

REV 1 - 12-15-2023 PROPERTY LINE PROPERTY LINE Non-conforming wall SINGLE FAMILY RESIDENCE **104 BLACKBURN AVE 108 BLACKBURN AVE 112 BLACKBURN AVE STREETSCAPE ELEVATION** SCALE :

ISSUED / REVISED

108 BLACKBURN AVE, MENLO PARK, CA 94025


NO. STREET CITY ZIPCODE

SHAH DESIGNS

DRAWN : AJ

CHECKED : RS

DATE: 12-15-2023

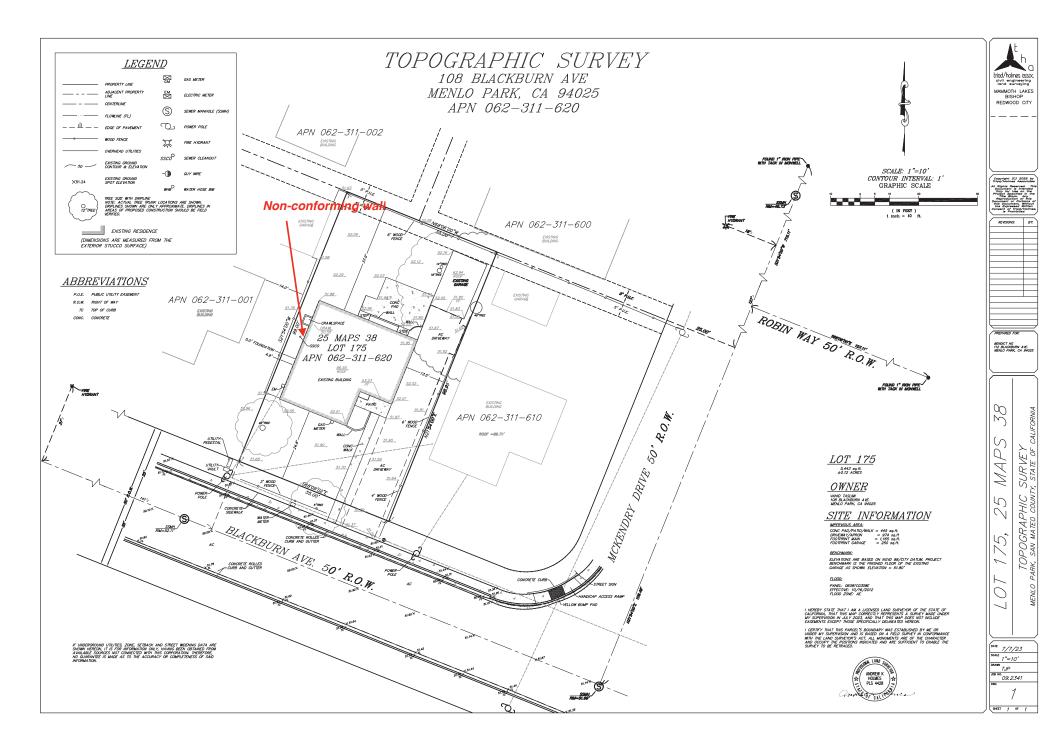

EXISTING WALL
WALL REMOVAL

ISSUED / REVISED

SINGLE FAMILY RESIDENCE

NO. 108
STREET BACKBURN AVE,
CITY MENLO PARK, CA
ZIPCODE 94025

SHAH DESIGNS


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SCALE : 1/4":12"


DATE: 12-15-2023


**A4** 



**EXISTING FLOOR PLAN** 

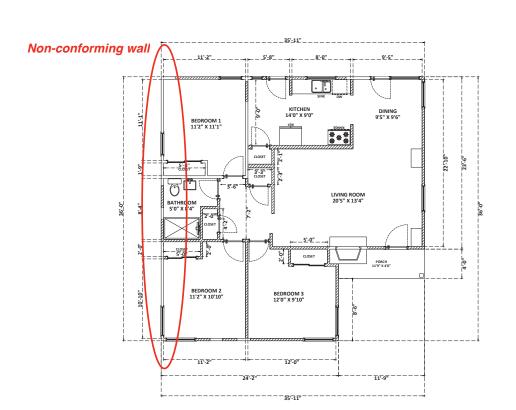
1/4" = 1'0"

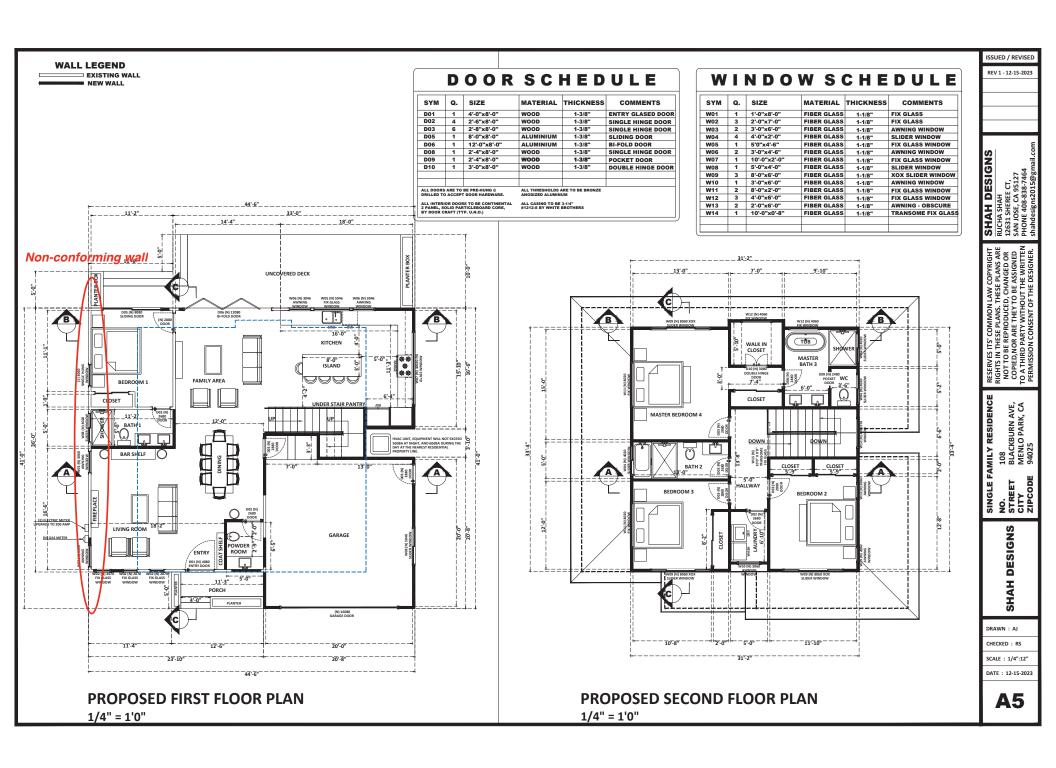

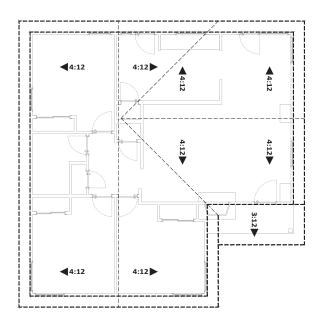

**EXISTING ROOF PLAN** 

1/4" = 1'0"

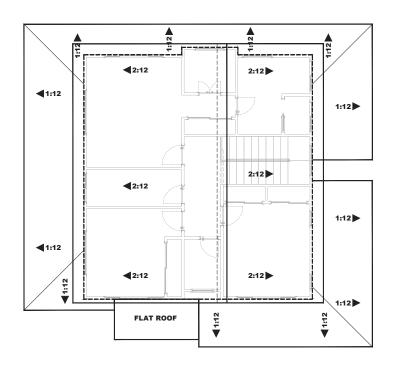

**PROPOSED ROOF PLAN** 

1/4" = 1'0"

ISSUED / REVISED

SINGLE FAMILY RESIDENCE

NO. 108
STREET BLACKBURN AVE,
CITY MENLO PARK, CA
ZIPCODE 94025

SHAH DESIGNS

DRAWN : AJ

SCALE : 1/4":12" DATE: 12-15-2023





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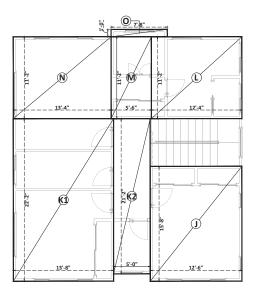
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DATE: 12-15-2023







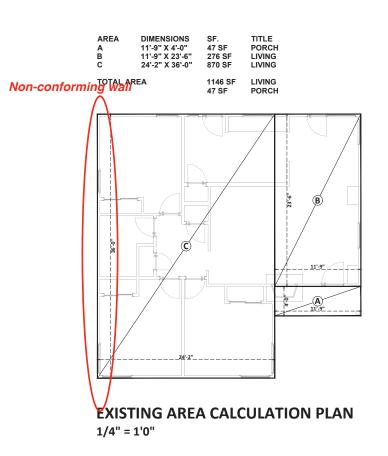
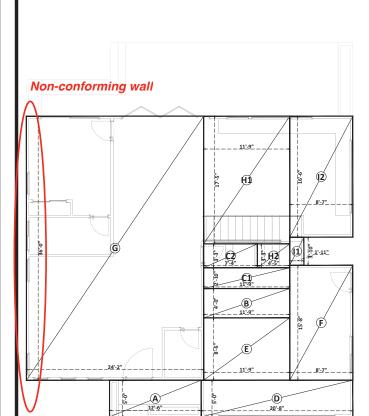
# PROPOSED FIRST FLOOR AREA **CALCULATION PLAN**

1/4" = 1'0"

# PROPOSED SECOND FLOOR AREA **CALCULATION PLAN**

1/4" = 1'0"

ISSUED / REVISED

 NO.
 108

 STREET
 BLACKBURN AVE,

 CITY
 MENLO PARK, CA


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 94025


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CHECKED : RS SCALE : 1/4":12"

DATE : 12-15-2023



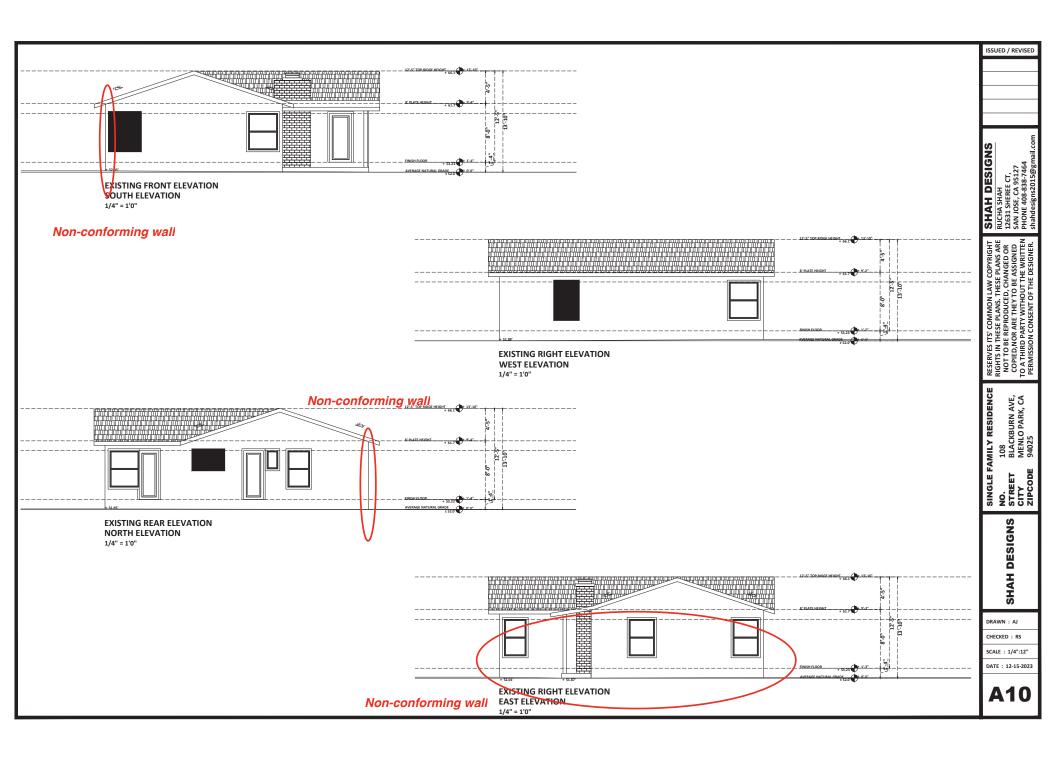

PROPOSED RIGHT ELEVATION (WEST ELEVATION)

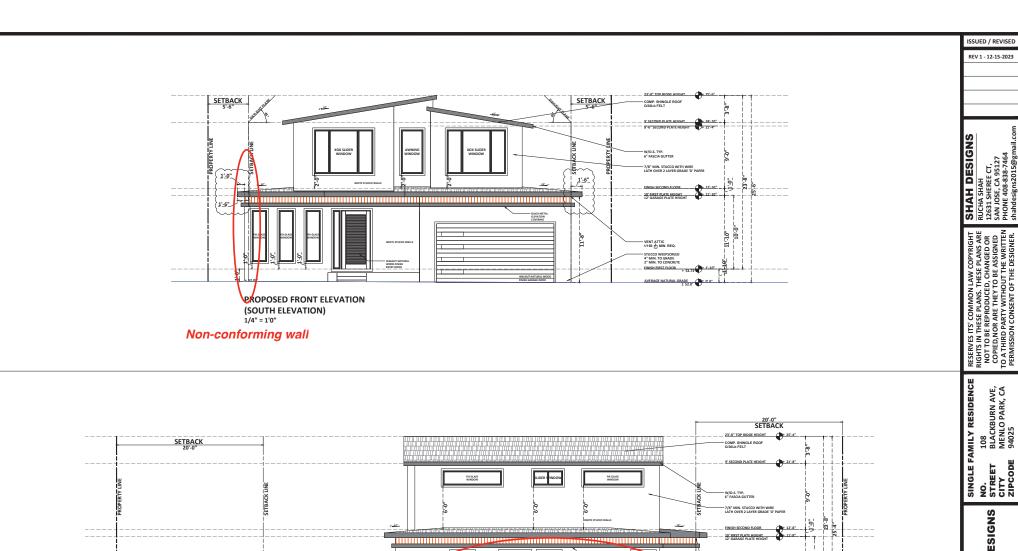1/4" = 1'0"

Non-conforming wall

SHAH DESIGNS

DRAWN : AJ

CHECKED : RS

SCALE : 1/4":12" DATE: 12-15-2023

ISSUED / REVISED REV 1 - 12-15-2023 SHAH DESIGNS
RUCHA SHAH
12631 SHEREE CT,
SAN JOSE, CA 95127
PHONE 408-838-7464
shahdesigns2015@gmail.com 1'-0" 10' FIRST PLATE HEIGHT 12' GARAGE PLATE HEIGHT 1'-6" PROPOSED REAR ELEVATION (NORTH ELEVATION) 1/4" = 1'0" Non-conforming wall SINGLE FAMILY RESIDENCE
NO. 108
STREET BLACKBURN AVE,
CITY MENLO PARK, CA
ZIPCODE 94025 20'-0" SETBACK 23'-8" TOP RIDGE HEIGHT 25'-8" SETBACK 20'-0" SU ER WIN OW FIX GLASS WINDOW 10' FIRST PLATE HEIGHT 12' GARAGE PLATE HEIGHT

PROPOSED LEFT ELEVATION (EAST ELEVATION)

1/4" = 1'0"

SHAH DESIGNS

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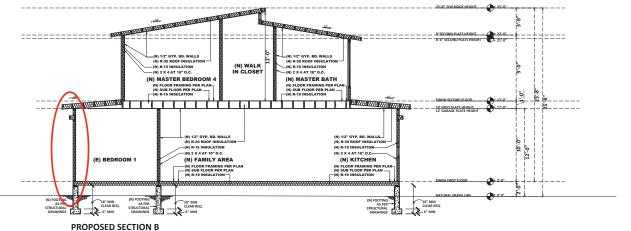
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SCALE : 1/4":12"

DATE : 12-15-2023

DATE : 12-15-20

(N) HALLWAY \_\_(N) 1/2" GYP. BD. WALI (N) R-30 ROOF INSULA \_\_(N) R-15 INSULATION \_\_(N) 2 X 4 AT 16" O.C. (N) BEDROOM 3 (N) BEDROOM 2 10' FIRST PLATE HEIGHT (N) 1/2" GYP. BD. WALLS
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(N) R-15 INSULATION
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1/4" = 1'0"

Non-conforming wall

ISSUED / REVISED

REV 1 - 12-15-2023

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shahdesigns2015@gmail.com

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 NO.
 108

 STREET
 BACKBURN AVE,

 CITY
 MENLO PARK, CA

 ZIPCODE
 94025

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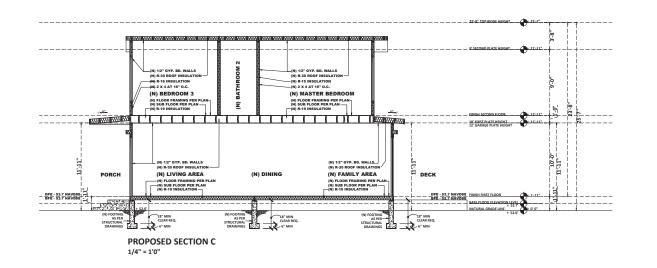
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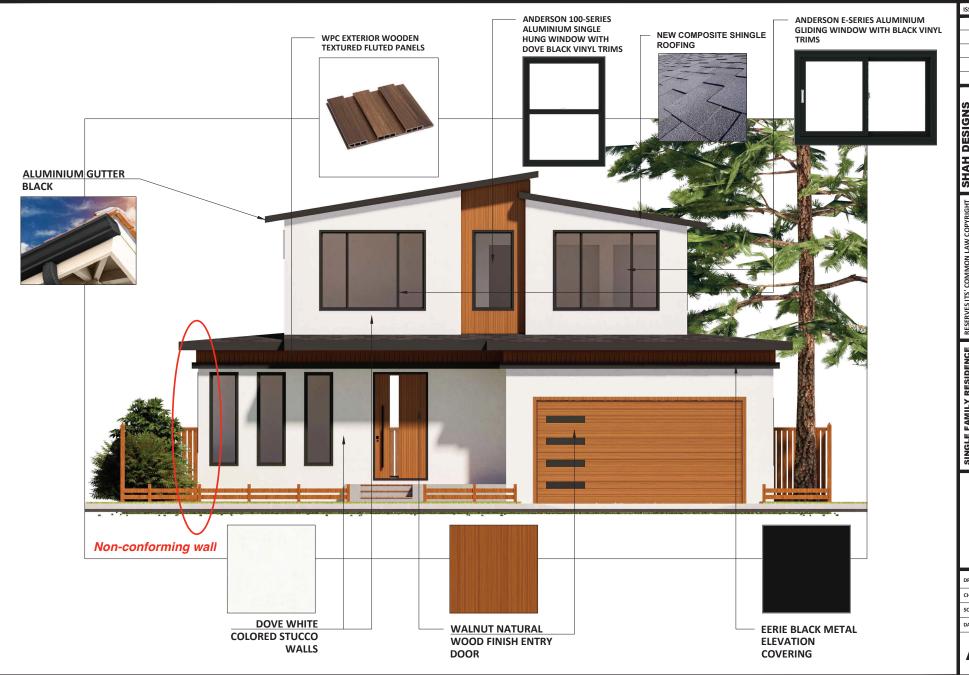
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DATE: 12-15-2023

**A14** 



Non-conforming wall



 NO.
 108

 STREET
 BLACKBURN AVE,

 CITY
 MENLO PARK, CA

 ZIPCODE
 94025


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DATE: 12-15-2023







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12631 SHEREE CT,

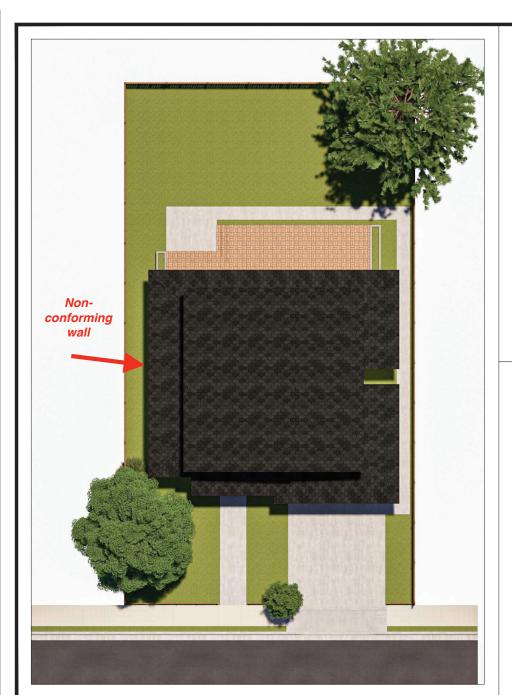SAN JOSE, CA 95127

PHONE 408-838-7464

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MENLO PARK, CA
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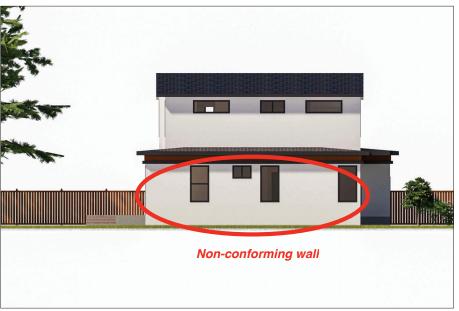
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NO. STREET CITY


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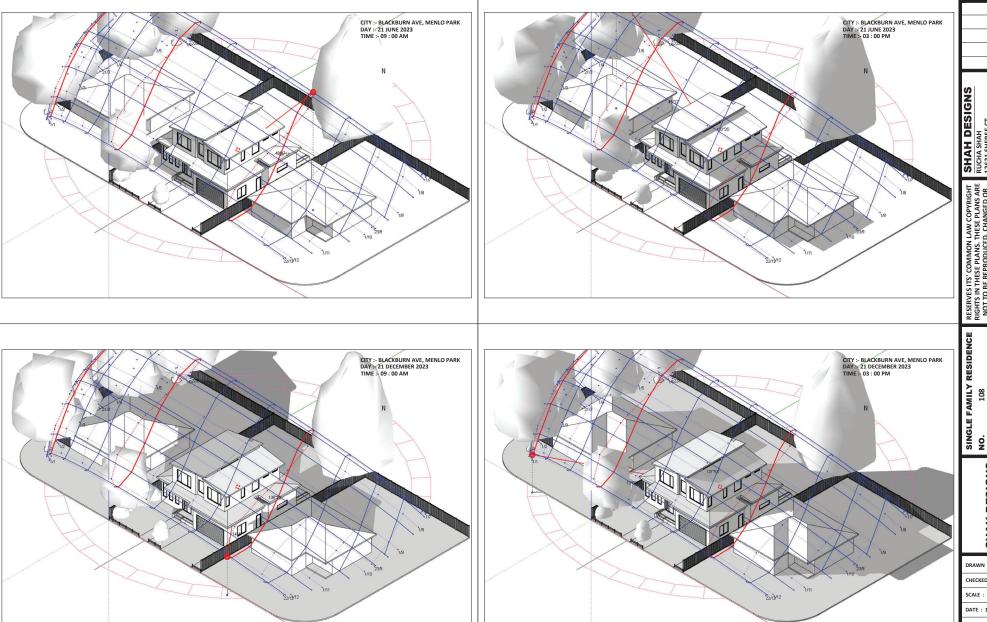


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SINGLE FAMILY RESIDENCE


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ZIPCODE 94025


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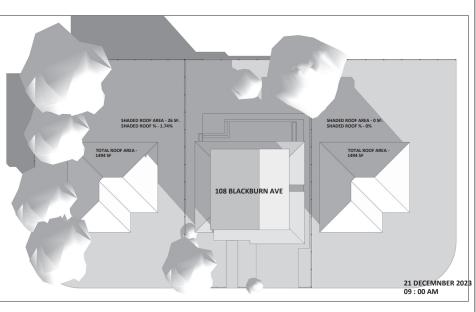
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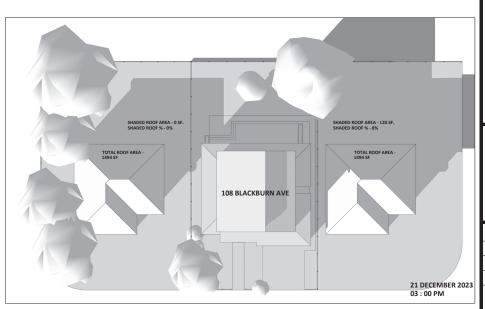
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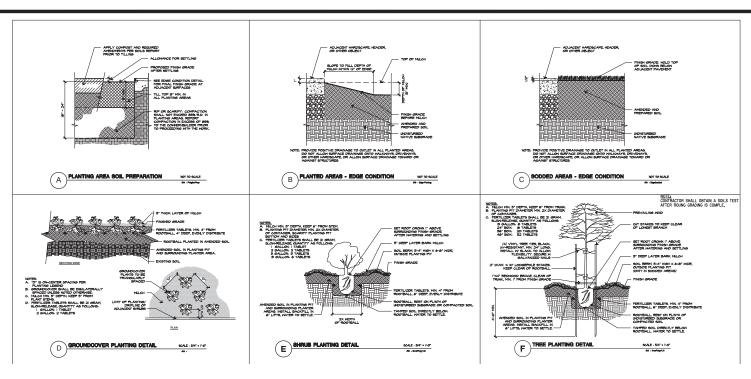
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ZIPCODE 94025

SHAH DESIGNS

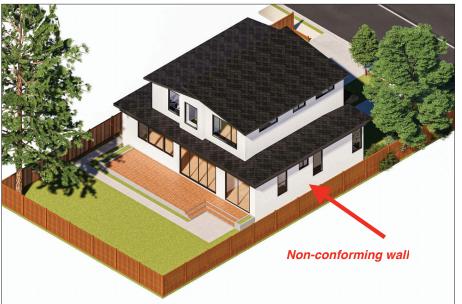DRAWN : AJ CHECKED : RS

SCALE :

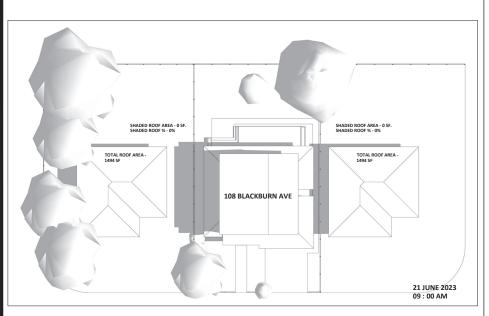DATE: 12-15-2023

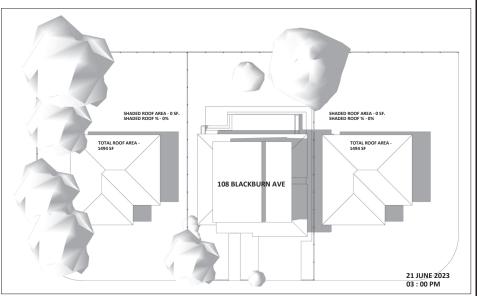

#### **DEMOLITION NOTES:**

11. SPECIFICATIONS. SEE GENERAL NOTES FOR ADDITIONAL INFORMATION INCLUDING UTILITIES VERIFICATION, PROTECTION, AND RESTORATION INFORMATION AND REQUIREMENTS.

2. CLEARING AND CRUBERING. CLEAR AND GRUB TO THE LIMITS OF WORK PER SPECIFICATIONS TAKING CARE TO NOT DISTURB HER ROOT SYSTEMS OF EMSING THESE TO REMAIN. HER ROOT SYSTEMS OF EMSING THESE TO REMAIN. HER ROOT SYSTEMS OF EMSING THESE TO REMAIN. HER STANDARD THE STANDARD THE STANDARD THE NEW PAYING WILL BE CONSTRUCTED NEXT TO EXISTING PAYING, TO THE PRANSITION CAM BE MADE FROM THE EXISTING PAYING TO THE PRANSITION CAM BE MADE FROM THE EXISTING PAYING TO THE PRANSITION CAM BE MADE FROM THE EXISTING PAYING TO THE CONSTRUCTION PAYING TO THE PROCESS OF THE STANDARD CAME BE MADE FROM THE EXISTING PAYING TO THE CONSTRUCTION OF THE STANDARD CAN BE MADE FROM THE EXISTING PAYING AT SUCH CONSTRUCT EXISTING PAYING THE SAME SEMEMAL SETS SEVERAL EXISTING TREES ARE

LOCATIONS IF NECESSARY.

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COST TO THE OWNER AT THEIR CURRENT SIZE.

CONTRACTOR TO VERIFY EXISTING DRANMAGE SYSTEM BEFORE CONSTRUCTION, SAVE AND PROTECT IN PLACE, REPAIR AS RECOURSED.

- REQUIRED.
  CONTRACTOR TO VERIFY EXISTING LIGHTING & ELECTRICAL
  SYSTEMS, SAVE AND PROTECT IN PLACE, REPAIR AS REQUIRED.
  CONTRACTOR TO VERIFY EXISTING IRRIGATION SYSTEM BEFORE
  CONSTRUCTION, SAVE AND PROTECT IN PLACE, REPAIR AS

RECHIRE

REQUIRED.

3. DO NOT WILFULLY PROCEED WITH CONSTRUCTION ASDESIONED WHEN IT IS OBVIOUS THAT PROCEED AND, OR GRADE UNIVERSITY OF THE CONTROL OF SHALL BE CONTROL OF SHALL ASSUME THILL RESPONSIBILITY FOR ALL RECESSARY REVISIONS DUE TO FALLIEF TO GIVE SUCH NOTIFICATION.

#### GENERAL NOTES:

- CONTRACTOR TO FAMILIARIZE HIM/HERSELF WITH ALL SITE CONDITIONS PRIOR TO BIDDING ON PROJECT.
- PROJECT.

  2. CONTRACTOR SHALL CLEAN OUT AND REPAIR/REPLACE AS REQUIRED EXISTING DRAINAGE. SYSTEM AND GRADE SITE SO THAT THE SITE HAS POSITIVE DRAINAGE.

  3. ALL GRADINS SHALL BE IN ACCORDANCE WITH LOCAL GRADING CODES AND ORDINANCES.

  4. THE CONTRACTOR SHALL OBTAIN, COORDINATE AND PAY FOR ANY AND ALL PERMITS AND ALL INSPECTIONS AS REQUIRED.
- 5. ALL CONCRETE FLATWORK LAYOUT SHALL BE APPROVED BY OWNER AND/OR LANDSCAPE ARCHITECT PRIOR TO INSTALLATION.

  6. THE LOCATION AND PROTECTION OF ALL UTILITIES SHALL BE THE RESPONSIBILITY OF THE
- 7. ALL DIMENSIONS ARE FROM OUTSIDE FACE OF PAVING, WALLS, ETC., UNLESS OTHERWISE NOTED ON PLANS
- NOTED ON PLANS.

  8. ALL PROPERTY UNES AND LOT LINES SHALL BE VERIFIED PRIOR TO COMMENCING WORK.

  9. THE CONTRACTOR SHALL BE RESPONSIBLE AND LIABLE FOR ANY AND ALL DAMAGE DUE TO OPERATIONS, OR REGLECT OF SUBCONTRACTOR.

  10. ALL WALLS AND WALKS SHALL HAVE SMOOTH, CONTINUOUS CURVES AS INDICATED ON
- PLANS, JOIN ALL EXISTING PAVING FLUSH.
- TLANS. JOIN ALL EASTING PAYING FLUSH.

  11. APPROVED PROTECTIVE MEASURES AND TEMPORARY DRAINAGE PROVISIONS SHALL BE USED TO PROTECT THE ADJOINING PROPERTIES DURING GRADING OPERATIONS. 12. LANDSCAPE AREAS SHALL DRAIN AWAY FROM ALL BUILDINGS AND FACILITIES AT 2% MIN. 5' AS SHOWN ON THE PLAN.
- AS SHOWN ON THE PLAN.

  13. ALL MATTER OR DEBRIS SHALL BE REMOVED BY THE CONTRACTOR FROM THE SURFACE
  UPON WHICH FILL IS TO BE PLACED.

  14. DUST SHALL BE CONTROLLED BY WATERING.

  15. EXPORTED SOIL AND DEBRIS SHALL GO TO A LEGAL DUMPSITE AT NO ADDITIONAL COST TO
- THE OWNER.

THE OWNER.

16. ALL LANDSCAPE AREAS SHALL BE SMOOTH IN CHARACTER AND SHALL HAVE NATURAL TRANSITIONS BETWEEN CONTOURS AS DIRECTED BY THE LANDSCAPE ARCHITECT.

17. LANDSCAPE MOUNDS AND FUL AREAS SHALL BE SPREAD IN LOOSE LIFTS OF 6 INCHES OR LESS AND COMPACTED TO A DEGREE OF 95% OR GREATER.

18. DO NOT MULTULLY PROCESS WITH CONSTRUCTION ASSESSINGED WHEN IT IS OBVIOUS THAT

UNKNOWNOBSTRUCTIONS, AREA DISCREPANCIES AND/OR GRADE DIFFERENCES EXIST THAT MAY NOT HAVE BEEN KNOWN DURING DESIGN. SUCH CONDITIONS SHALL BEIMMEDIATELY BROUGHT TO THE ATTENTION OF THE OWNER. THE CONTRACTOR SHALL ASSUME FULL RESPONSIBILITY FOR ALL NECESSARY REVISIONS DUE TO FAILURE TO GIVE SUCH

### GRADING NOTES:

1. EXISTING GRADES ARE USED BASED ON INFORMATION DIRECTLY FROM CIVIL ENGINEER'S PLANS. VERIFY EXISTING GRADES FOR ACCURACY PRIOR TO THE START OF GRADING AND NOTIFY THE OWNER AND LANDSCAPE ARCHITECT IMMEDIATELY SHOULD

CONFLICTS ARISE.

2. THE LAYOUT OF PIPING AND ACCESSORIES IS DIAGRAMMATIC UNLESS SPECIFICALLY DIMENSIONED, PRIOR TO GRADING, VERIFY UNDERGROUND UTILITY LOCATIONS, EMSTING DRAINAGE STRUCTURES, AND STREET IMPROVEMENTS WHICH MAY INTERFERE WITH THE WORK TO BE DONE, CONTACT THE INTERFERE WITH THE WORK TO BE DONE. CONTACT THE UNDERFROUND SERVICE. ALERT (USA) (800)624–2444 PRIOR TO DIGORIC. NOTIFY THE OWNER AND LANDSCAPE ARCHITECT 3. PROPOSED PAVING SURFACES SHALL MEET PAVED SURFACES WITH A SMOOTH AND CONTINUOUS TRANSITION. LOW SPOTS WHICH HOLD STANDING WATER WILL NOT BE PERMITTED.

4. STEEN TREAD SURFACES SHALL BE SLOPED AT 1% FOR STANDING WATER WILL NOT BE PERMITTED.

5. STEEN TREAD SURFACES SHALL BE SLOPED AT 1% FOR STANDING WATER STANDING

WALKWAYS SHALL BE INSTALLED WITH A MAXIMUM CROSS SLOPE OF 2% AND SHALL MEET ALL LOCAL AND COUNTY

SEOPE OF 28 AND SHALL MEET ALL BLOCK AND COUNTY
6. WHEN UTILIZED, CARE SHALL BE TAKEN TO ACCURATELY
CENTER ALL DECK DRAINS WITHIN AREA BETWEEN CONCRETE
EXPANSION JOINT AND SCORE LINES AS SHOWN ON THE

EPRANSION JOINT AND SCORE LINES AS SHOWN ON THE PARSION AND SCHOOL STATEMENT OF THE PARSON SHALE SECRED AT MINIMUM OF 2% TOWARDS CATCH BASINS AND SWALES AS SHOWN ON PLAN. LOW SPOTS WHICH HOLD STANDHING WATER WILL NOT BE PERMITTED. POSITIVE DRAINAGE AWAY FROM BUILDING FOUNDATIONS, AND PROFESTY LINES IS IMPERATIVE. NOTIFY THE LANDSCAPE ARCHITECT IMMEDIATELY SHOULD CONFLICTS OF THE PARSON OF TH

ARISES.

8. GROUNDCOVER AREAS SHALL BE 2", LAWN AREA 1" BELOW TOP OF ADJACENT PAYING, EADERS, OR CURES, UNLESS OF CHERNING FOR THE PROPERTY OF THE PROPERTY OF

FACE OF EXISTING CURBS 1" ABOVE THE FLOW LINE. POOLS, SPAS, AND FOUNTAINS SHALL BE DRAINED PER

1. POOLS, SFAS, AND FOUNTAINS SHALL BE DRAINED PER LOCAL CODES AND REQUIREMENTS. 2. WHEN POSSIBLE, CLEAN TOPSOIL SHALL BE REMOVED FROM AREAS TO BE PAVED AND STOCKPILED TO BE USED AT BACKFILL IN PLANTING AREAS. 3. REFER TO PLANTING PLANTS FOR SLOPE STABILIZATION AND

J. REPER TO PLANNING PLANTS FOR SLOPE STABILIZATION AND PLANTING REQUIREMENTS HOULD SLOPE EXCEED 3:1. NOTIFY THE OWNER AND LANDSCAPE ARCHITECT IMMIEDIATELY SHOULD FIELD CONDITIONS ARISE WHICH INCREASE THE MAXIMUM PROPOSED SLOPE GRADES.

#### PLANTING NOTES:

- CONTRACTOR SHALL BE RESPONSIBLE FOR MAKING HIMSELF FAMILIAR WITH ALL EASEMENTS, UNDERGROUND UTILITIES, PIPES AND STRUCTURES, CONTRACTOR SHALL TAKE SOLE RESPONSIBILITY FOR ANY COST INCURRED DUE TO DAMAGE OF
- EASMENTS: ONLEGROUDUD UILIUES, PIES AND STRUCTURED DUE TO DAMAGE OF SAID LITHIUES. E RESPONSIBILITY FOR ANY COST INCURRED DUE TO DAMAGE OF SAID LITHIUES. E RESPONSIBILITY FOR ANY COST INCURRED DUE TO DAMAGE OF SAID LITHIUES. DE STRUCTURES, ARE DISCREPANCES SAND/OR GRADE DIFFERENCES EXIST THAT MAY NOT HAVE BEEN KNOWN DURIND DESIGN, SUCH CONDITIONS SHALL BE MEMBLATE FULL RESPONSIBILITY FOR ALL NECSSARY HELD CONTROLL. SAILL ASSUME FULL RESPONSIBILITY FOR ALL NECSSARY LANDSCAPE AREAS SHALL DRAWN MAY FROM ALL BUILDINGS AND FACILITIES AT 2% MIN. FOR 5' AS PER DRAINAGE PLAN. FOLLOW ALL DRAINAGE PLANS. ALL PLANT MATERIAL SHALL BE OF INVESTED YOULTH AND BE GUARANTEED FOR THREE MONTHS.

  ALL PLANT MATERIAL SHALL BE APPROVED FOR QUALITY BY THE OWNER AND/OR THREE MONTHS.

  ALL PLANT MATERIAL SHALL BE APPROVED FOR QUALITY BY THE OWNER AND/OR. FINAL LOCATION OF ALL PLANT MATERIAL SHALL BE SUBJECT TO THE APPROVAL OF THE OPPORTUNITY OF THE OWNER.

  SOIL DEPERABATION.

- SOIL PREPARATION:

   ROTOTILL THE FOLLOWING AMENDMENTS 6" INTO THE SOIL AT RATES INDICATED PER 1,000 SQUARE FEET FOR ALL PLANTING AREA AND SOD AREAS.
   6 CUBIC YARDS NITROCORE STABILIZED SAMOUST OR EQUAL.
   125 LBS. GRO-POWER PLUS OR EQUAL PRE PLANT FERTILIZER.

   8. A SITE SEPCIFIC SOIL, ANALYSIS SHOULD BE FOLLOWED BY CONTRACTOR PER WELO REQUIREMENT.
   8. PLANT PITS SHALL BE 2X THE ROOT BALL SIZE WITH 70% NATIVE SOIL AND 30% AMENDMENTS WITH PLANT TABLETS OR OTHER PRE PLANT FERTILIZER.
   9. ALE PLANTS SHALL HAVE A 2" MIN. WATERING BERM AROUND THEM.

- 10. TREES ARE TO BE STAKED WITH A MIN. 2"X2"X REQUIRED HEIGHT STAKE AND TIED TO INSURE VERTICAL GROWTH.

  11. ALL PLANTING AREAS SHALL BE WATERED WITH AN AUTOMATIC IRRIGATION
- SYSTEM.

  12. ALL APPLICABLE CODES TO BE FOLLOWED. ALL WORK REQUIRING PERMITS SHALL HAVE PERMITS BEFORE WORK IS TO BEGIN.

  13. ALL PLANTING AREAS TO BE COVERED WITH 3' THICK LAYER OF PREMIUM ARBOR MULCH
- ANDUM MULCH

  14. ALL TREE ROOTS GREATER THAN 1-1/2" IN DIAMETER DAMAGED DURING
  CONSTRUCTION SHALL BE CUT CLEAN AND SEALED.

  15. CONTRACTOR TO VERIFY QUANTITIES, QUANTITIES SHOWN ARE FOR REFERENCE
  ONLY

SCALE :

ISSUED / REVISED

DESIGNS

ANGED OR ANGED OR ASSIGNED WRITTEN

108 BLACKBURN AVE, MENLO PARK, CA 94025 RESIDENC FAMILY

NO. STREET CITY ZIPCODE

SINGLE

5 ESI SHAH

DRAWN · AI

CHECKED : RS

DATE: 12-15-2023